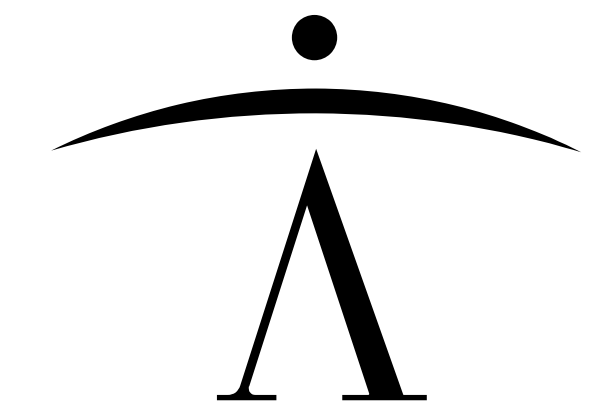
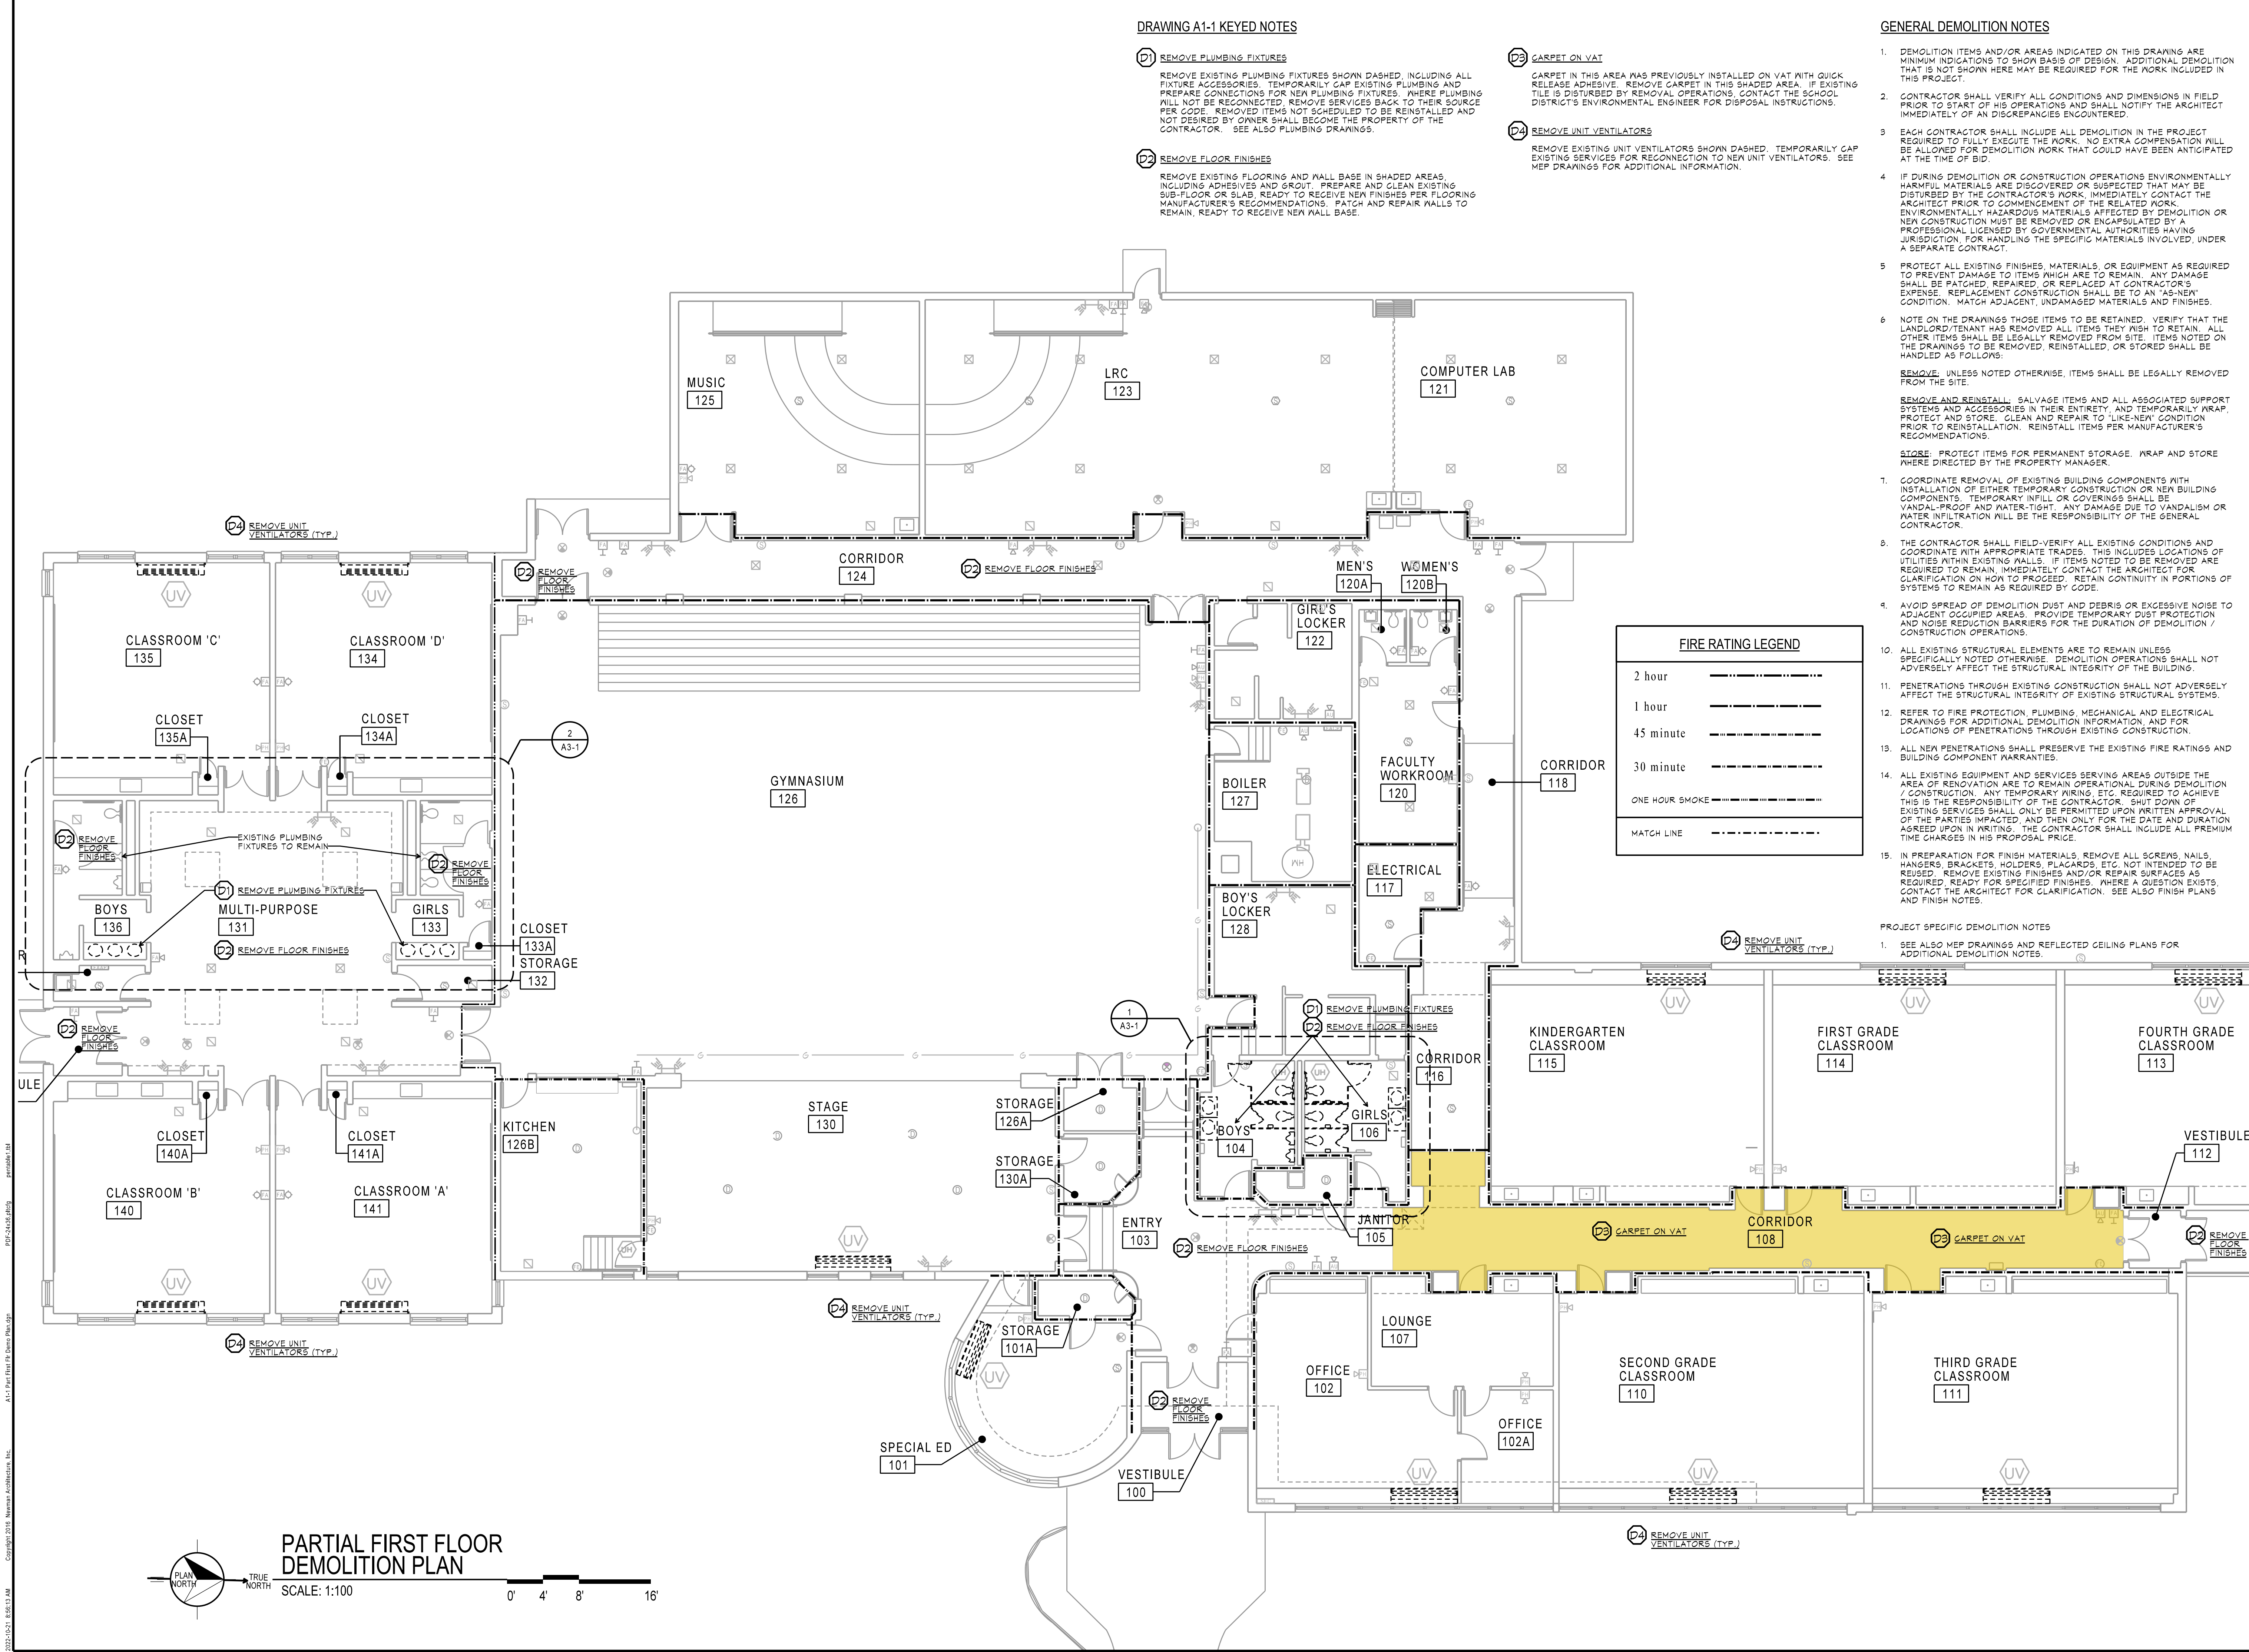


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A1-1 Part First Floor Demolition Plan
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Project Name:

CONSTRUCTION DOCUMENTS

**ESWOOD
SCHOOL**

**BUILDING
IMPROVEMENTS -
SUMMER 2023**

ESWOOD ELEMENTARY SCHOOL
304 N. MAIN STREET
LINDENWOOD, ILLINOIS 61049

FOR
BOARD OF EDUCATION
ESWOOD CCSD 269

Architect's Certification:

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License No. 184-000549
Expires: 2023-04-30
License: Illinois Registration No. 001-009496
Expires: 2022-11-30

Signature _____ Date 2022-10-20


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**PARTIAL FIRST FLOOR
DEMOLITION PLAN**

Issue/ Revision:

| No. | Date | Description |
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| - | 2022-10-20 | For Client Review |

Project Manager: CRN
Project No.: 2022027 Date: 2022-10-20

A1-1

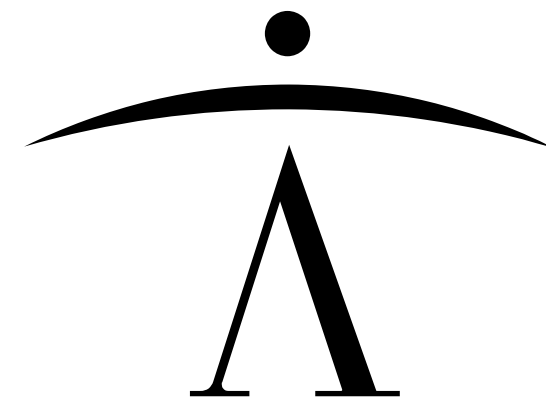

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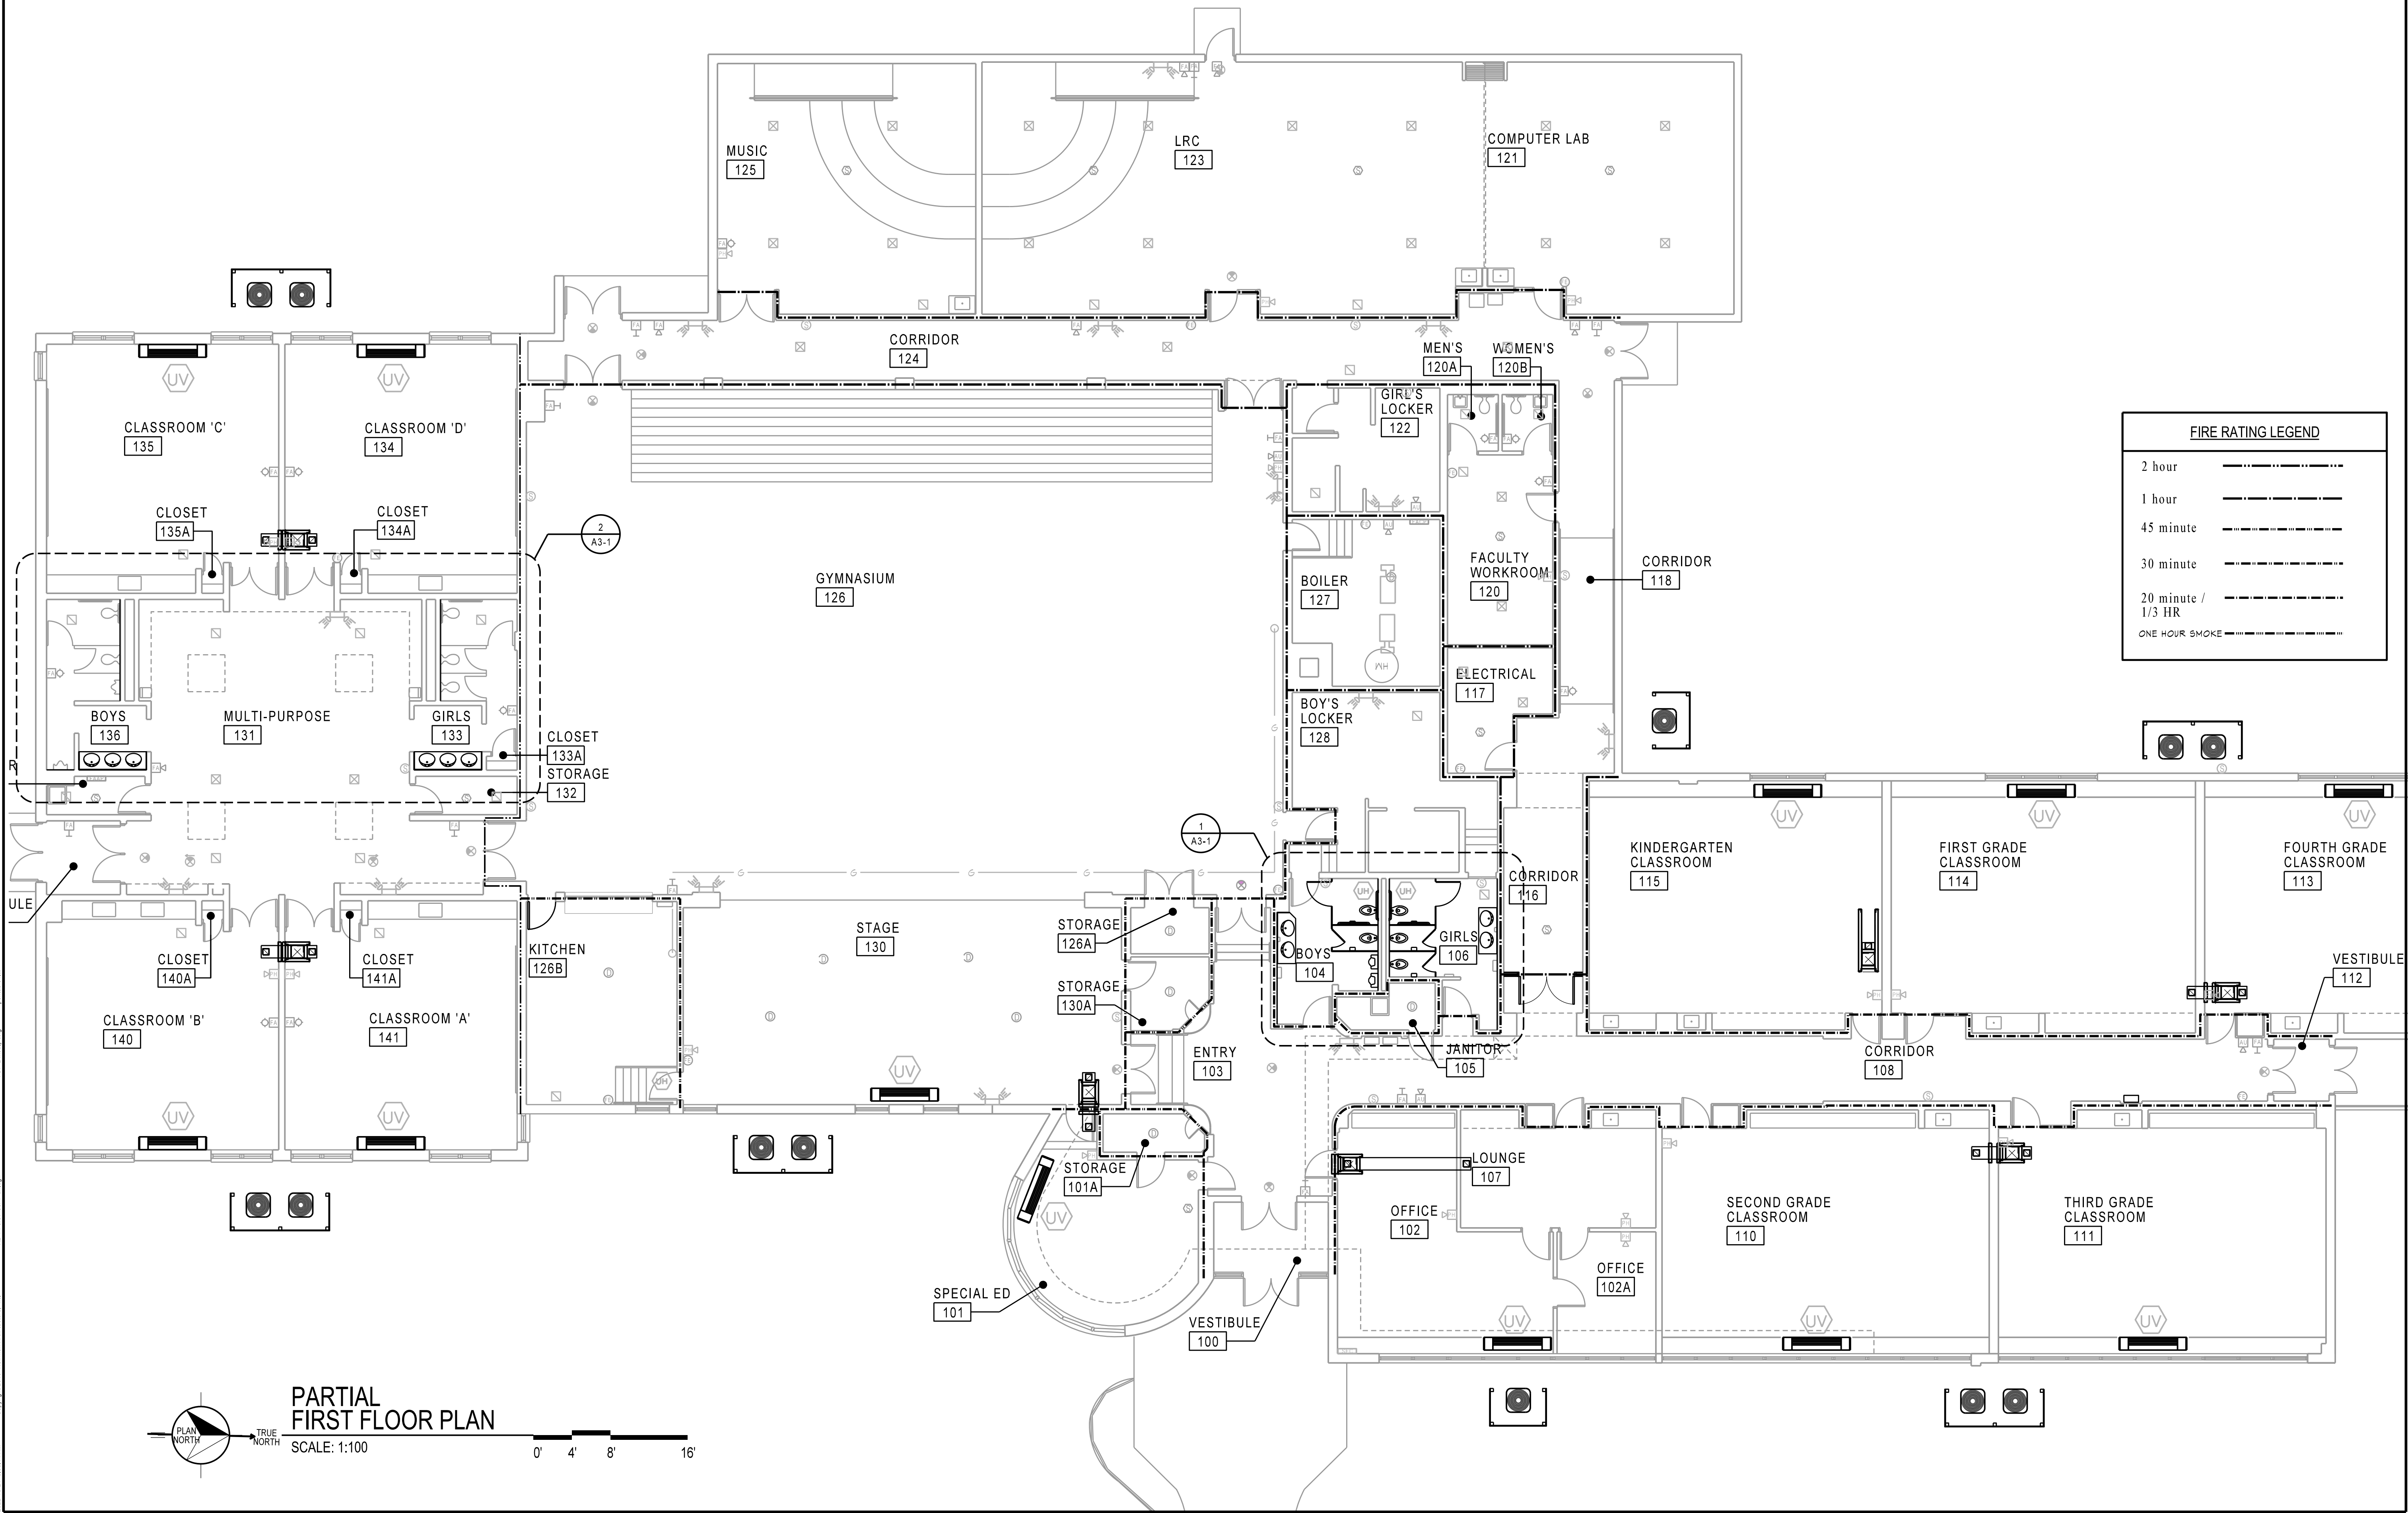
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PARTIAL FIRST FLOOR
PLAN

Issue/ Revision:

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| - | 2022-03-14 | For Client Review |

Project Manager: CRN
Project No.: 2022021 Date: 2022-03-14



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A2-1 Partial Floor Plan.dgn



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A2-1 Partial Floor Plan.dgn



1
A3-1
ENLARGED TOILET ROOM PLAN
SCALE: 1/4"=1'-0"

0' 2' 4' 8'

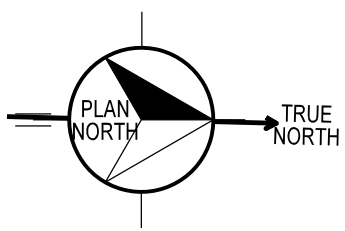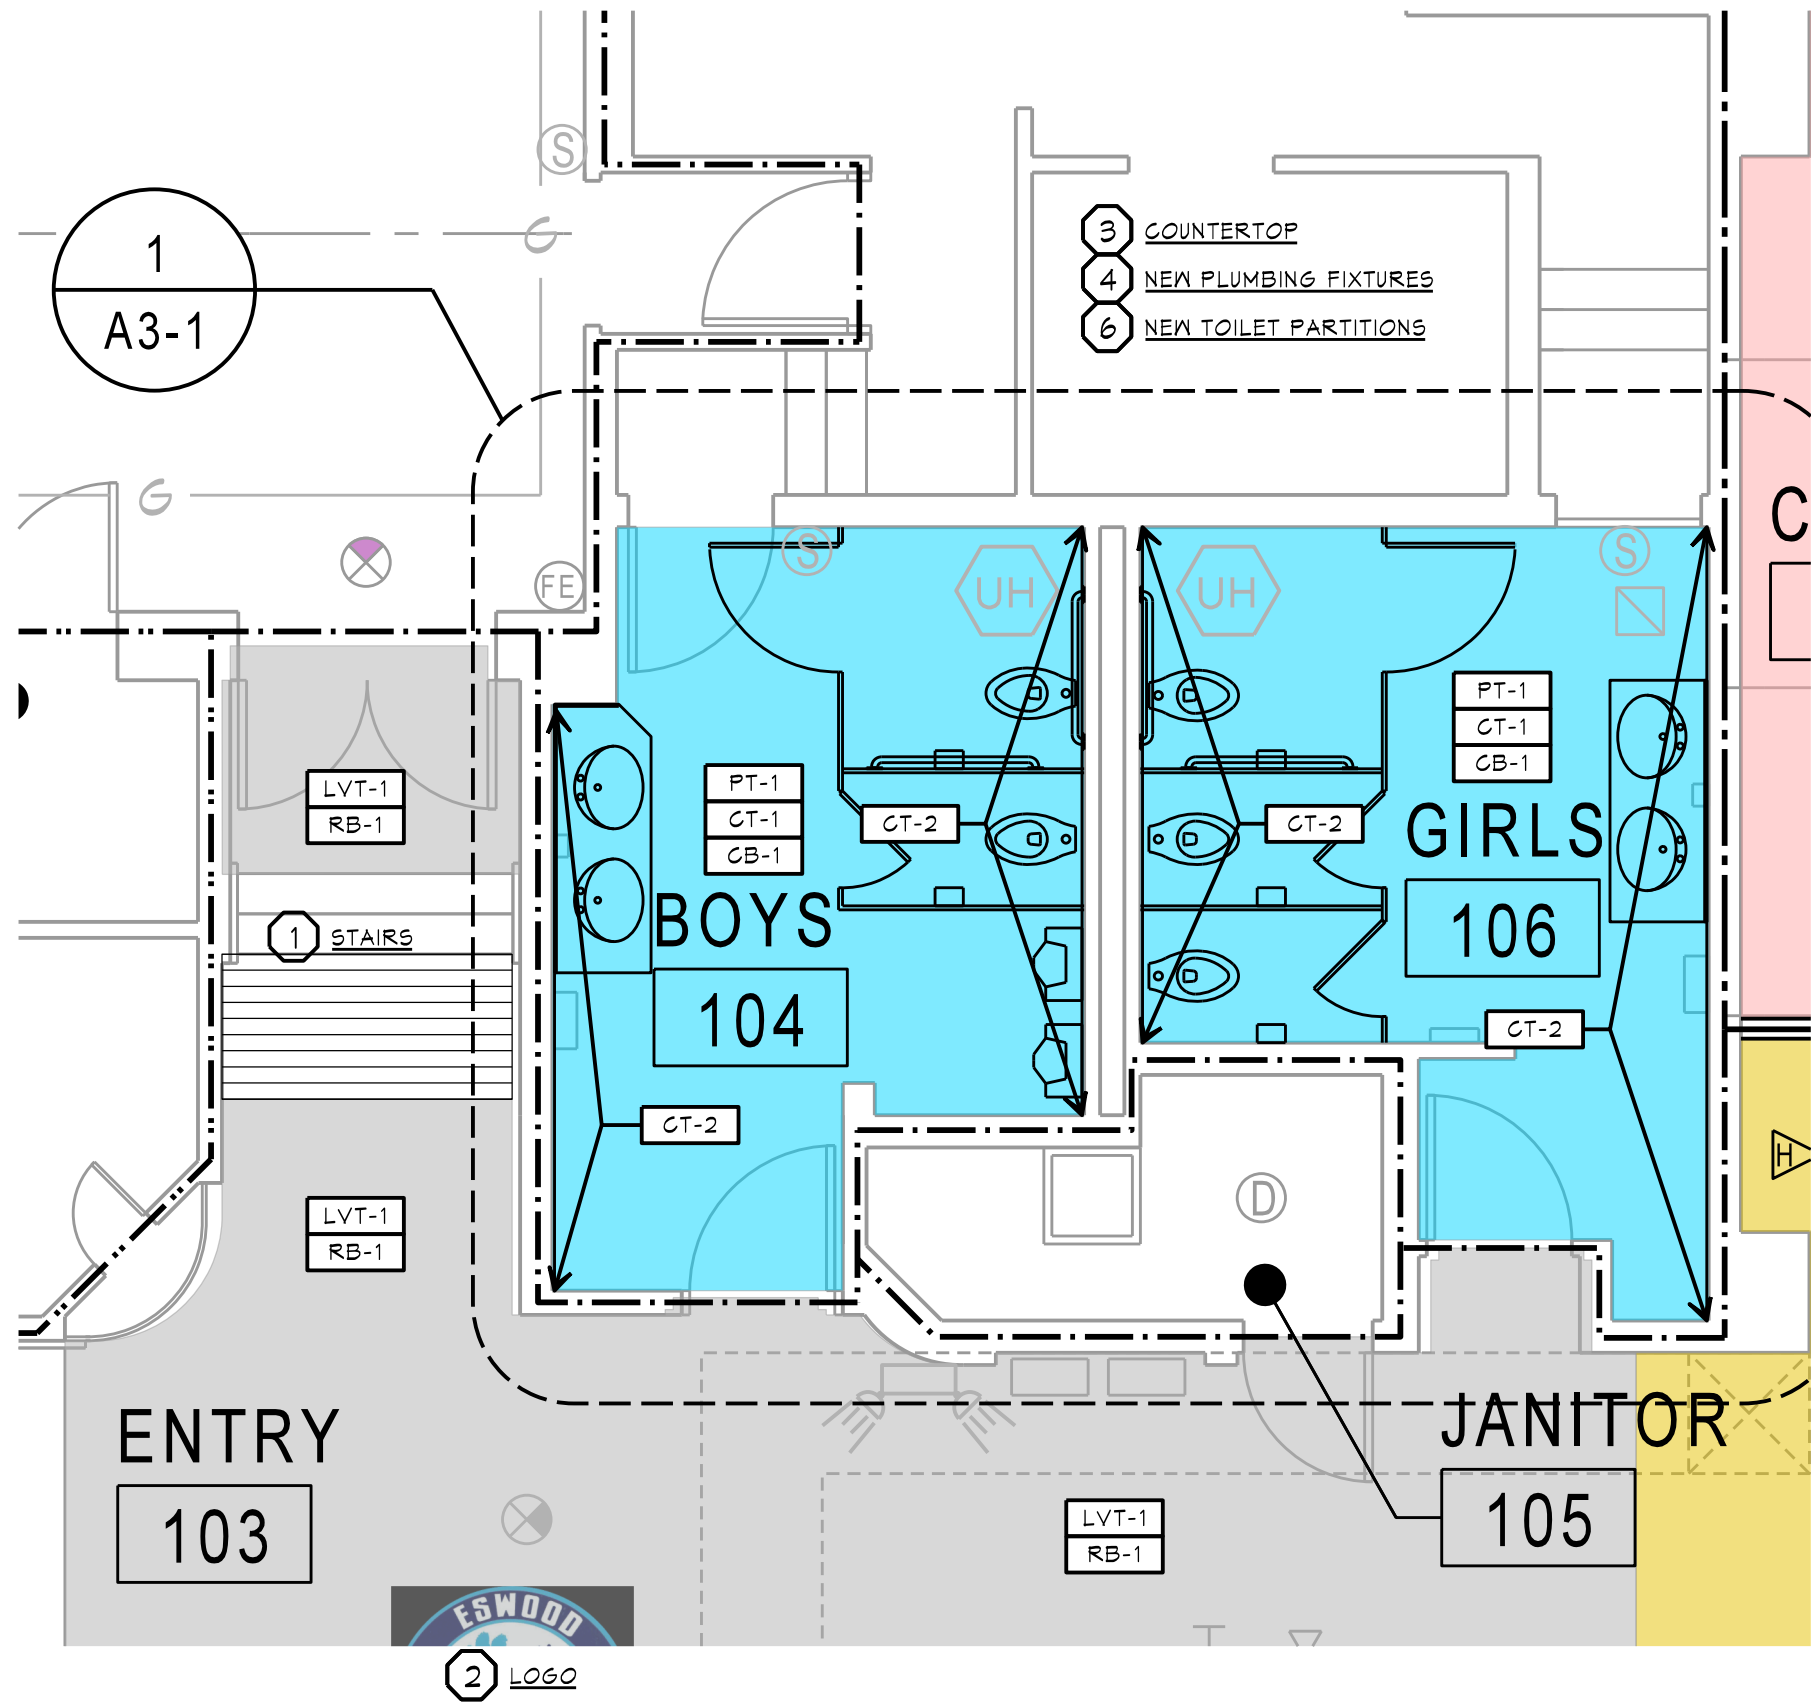

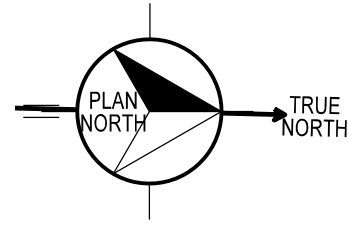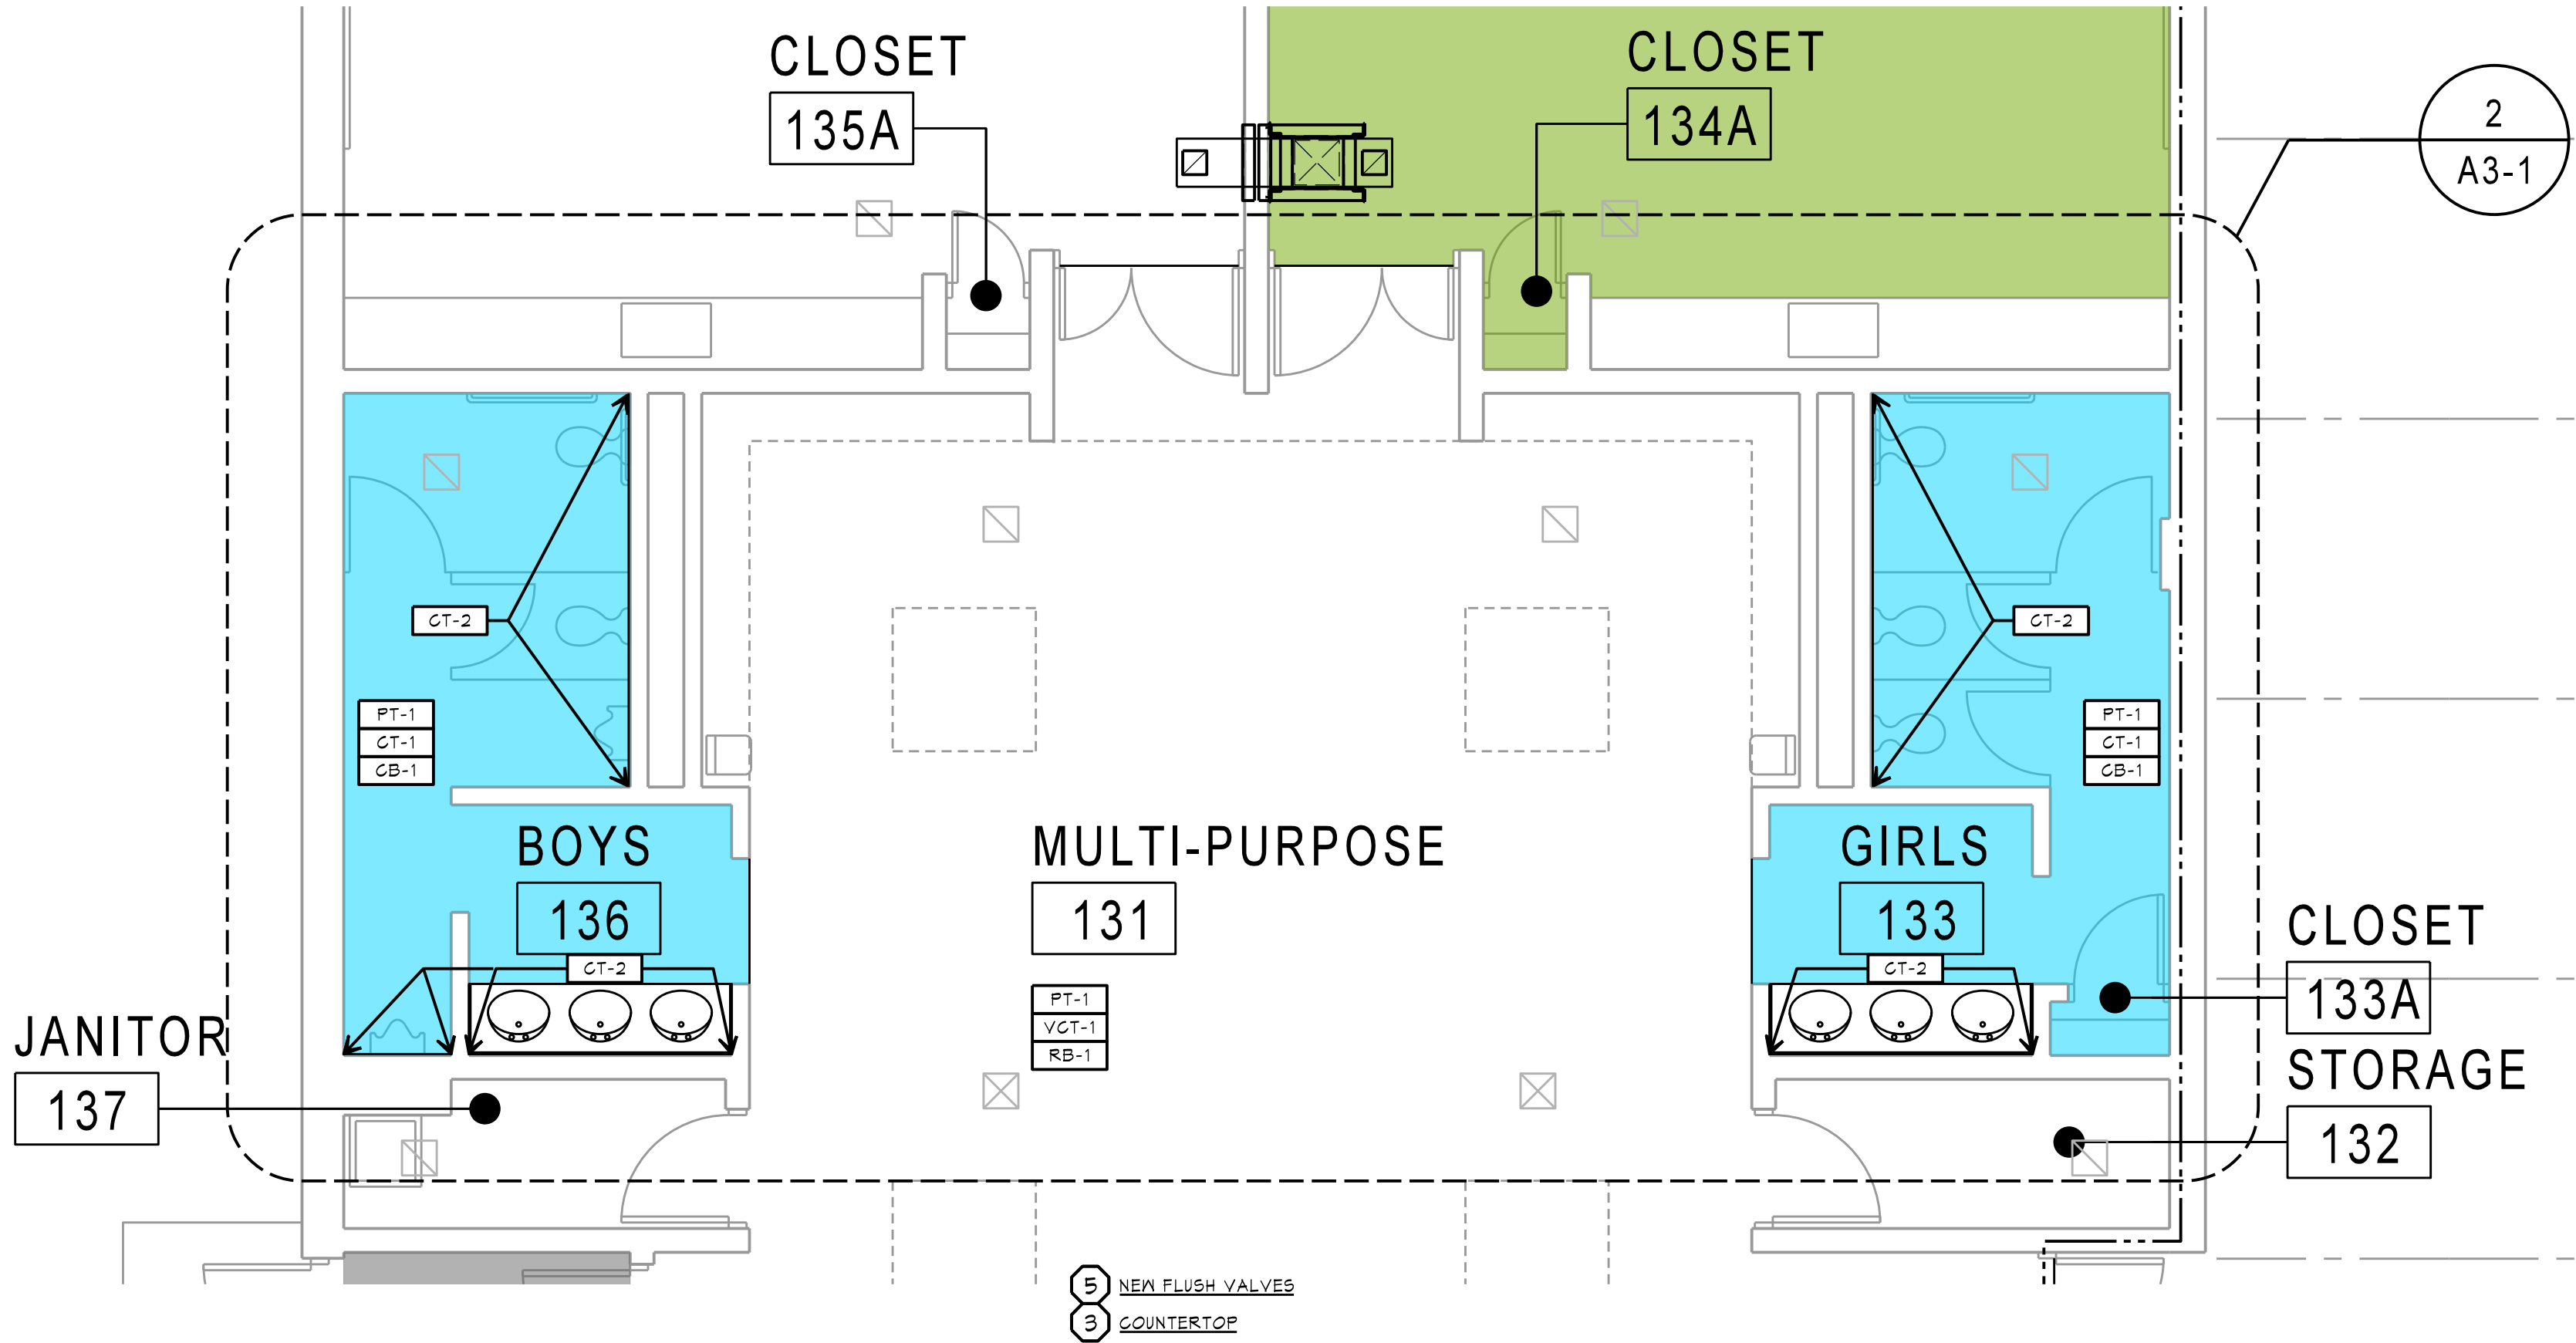2
A3-1
ENLARGED TOILET ROOM PLAN
SCALE: 1/4"=1'-0"

DRAWING A3-1 KEYED NOTES

- STAIRS**
TACTILE STAIR TREADS, NOSINGS, AND WARNING SURFACES SHALL REMAIN.
- LOGO**
INSERT 5' x 5' SCHOOL LOGO PLUSH WITH FINISHED FLOORING. ARTWORK WILL BE PROVIDED BY OWNER.
- COUNTERTOP**
PROVIDE NEW COUNTERTOP (SS-1) AND UNDER MOUNT SINKS. SEE ALSO PLUMBING DRAWINGS.
- NEW PLUMBING FIXTURES**
REPLACE EXISTING PLUMBING FIXTURES WITH NEW PLUMBING FIXTURES. SEE PLUMBING DRAWINGS.
- NEW FLUSH VALVES**
REPLACE EXISTING PLUMBING FLUSH VALVES WITH NEW TOUCH-FREE FLUSH VALVES. SEE PLUMBING DRAWINGS.
- NEW TOILET PARTITIONS**
REPLACE EXISTING TOILET PARTITIONS WITH NEW TOILET PARTITIONS. SEE TOILET ACCESSORY SCHEDULE.

FINISH SCHEDULE

| TAG | LOCATION | MFG. | PATTERN/COLOR | SIZE | REMARKS |
|------------------------------------|---|-----------------------|---|-------------------------|---|
| ACT-1 | ALL AREAS | ARMSTRONG | TILE: SCHOOL ZONE FINE FISSURED MODEL: 1714 COLOR: WHITE GRID: 15/16" | 24" x 48" | NON-DIRECTIONAL SAG RESISTANT CEILING TILE 30-YEAR WARRANTY |
| CB-1 | TOILET ROOMS | DALTILE | SERIES: COLORWHEEL COLLECTION - CLASSIC COLOR: 1174 SEA BREEZE FINISH: GLOSS GROUT: MAPEI 101 RAIN | 3" x 6" | INSTALLATION: SUBWAY OFFSET PROVIDE SCHLUTER DILEX-AHKA COVE-SHAPED TRIM BETWEEN WALL TILE AND FLOOR TILE. FINISH: SATIN ANODIZED ALUMINUM. MATCH KINDERGARTEN TOILET ROOM. |
| CT-1 | TOILET ROOMS FLOOR TILE | DALTILE | TYPE: COVED BASE STYLE: REMINISCENT COLOR: SOUVENIR GRAY RM22 FINISH: MATTE GROUT: MAPEI 101 RAIN | 12" x 12" | INSTALLATION: RUNNING BOND |
| CT-2 | TOILET ROOMS WALL TILE - WET WALLS | DALTILE | SERIES: COLORWHEEL COLLECTION - CLASSIC COLOR: 1174 SEA BREEZE FINISH: GLOSS GROUT: MAPEI 101 RAIN | 3" x 6" | INSTALLATION: SUBWAY OFFSET |
| C-1 | CORRIDORS | | | | |
| C-2 | VESTIBULES | | | | |
| LVT-1 | WALK-OFF SURFACE | | | | |
| VINYL TILE | CLASSROOMS & MULTI- PURPOSE ROOM | | | | |
| PT-1 | PRIMARY WALL COLOR | SHERWIN WILLIAMS | FINISH: SEMI-GLOSS NUMBER/COLOR: OFF WHITE | - | |
| PT-9 | INTERIOR HM DOORS & FRAMES - CORRIDORS | SHERWIN WILLIAMS | FINISH: SEMI-GLOSS NUMBER/COLOR: ?? | - | |
| PT-10 | GYPSUM BOARD CEILINGS, BULKHEADS AND SOFFITS | SHERWIN WILLIAMS | FINISH: FLAT NUMBER/COLOR: #SW7007 CEILING BRIGHT WHITE | - | |
| RB-1 | | JOHNSONITE | MATERIAL: RUBBER TYPE: COVED AT LVT TYPE: STRAIGHT AT CARPET COLOR: DARK BROWN 44 | 4" | |
| RVS-1 | RIGID VINYL SHEET | INPRO | TYPE: RIGID VINYL SHEET ITEM #: 406 GAUGE: 1.5MM (1/16") COLOR: 0103 White Sand TYPE: SOLID SURFACE | 4' x 8' x 1/16" | INCLUDE ALL TRIM & ACCESSORIES FOR A COMPLETE FINISHED SYSTEM INSTALLATION. |
| SS-1 | COUNTERTOP | | | | |
| ABBREVIATIONS | | | | | |
| ACT - ACOUSTIC CEILING TILE | | PT - PAINT | | RB - RUBBER BASE | |
| VCT - VINYL COMPOSITION FLOOR TILE | | WN - WINDOW COVERINGS | | RVS - RIGID VINYL SHEET | |
| | | | | SC - SEALED CONCRETE | |

GENERAL FINISH PLAN NOTES

- SEE DRAWINGS A8-1 FOR ADDITIONAL GENERAL FINISH NOTES.

CERAMIC TILE NOTES

- CONTRACTOR SHALL VERIFY THAT SUBSTRATES FOR SETTING TILE ARE FIRM, DRY, CLEAN, FREE OF COATINGS THAT ARE INCOMPATIBLE WITH TILE-SETTING MATERIALS (INCLUDING CURING COMPOUNDS AND OTHER SUBSTANCES THAT CONTAIN SOAP, MAX, OIL, OR SILICONE), AND COMPLY WITH FLATNESS TOLERANCES REQUIRED BY ANSI A108.01 FOR INSTALLATIONS INDICATED. VERIFY THAT CONCRETE SUBSTRATES FOR CERAMIC TILE COMPLY WITH SURFACE FINISH REQUIREMENTS IN ANSI A108.01 FOR INSTALLATION.
- CONTRACTOR SHALL INSTALL CERAMIC TILE PER TILE COUNCIL OF NORTH AMERICA, INC. (TCNA)'S HANDBOOK FOR CERAMIC, GLASS, AND STONE TILE INSTALLATION FOR JOB SPECIFIC APPLICATION AND MATERIALS. COMPLY WITH PARTS OF ANSI A108 SERIES SPECIFICATIONS FOR INSTALLATION OF CERAMIC TILE THAT ARE REFERENCED IN TCNA INSTALLATION METHODS, AND APPLY TO TYPES OF SETTING AND GROUTING MATERIALS USED.
- PROVIDE BULLNOSE TRIM OR MANUFACTURER RECOMMENDED SCHLUTER TRIM AT EXPOSED EDGES AS REQUIRED FOR FINISHED APPEARANCE.
- PROVIDE CRACK ISOLATION MEMBRANE OVER EXPANSION JOINTS THAT MAY TELEGRAPH MOVEMENT THROUGH THE FLOOR FINISH.
- PROVIDE TILE MANUFACTURER RECOMMENDED EXPANSION JOINTS AT EXPANSION JOINTS THAT MAY TELEGRAPH MOVEMENT THROUGH THE TILE FINISH.
- CLEANING: ON COMPLETION OF PLACEMENT AND GROUTING, CLEAN ALL CERAMIC TILE SURFACES SO THEY ARE FREE OF FOREIGN MATTER. REMOVE GROUT RESIDUE FROM TILE AS SOON AS POSSIBLE. CLEAN GROUT SMEARS AND HAZE FROM TILE ACCORDING TO TILE AND GROUT MANUFACTURER'S WRITTEN INSTRUCTIONS, BUT NO SOONER THAN 10 DAYS AFTER INSTALLATION. USE ONLY CLEANERS RECOMMENDED BY TILE AND GROUT MANUFACTURERS AND ONLY AFTER DETERMINING THAT CLEANERS ARE SAFE TO USE BY TESTING ON SAMPLES OF TILE AND OTHER SURFACES TO BE CLEANED. PROTECT METAL SURFACES AND PLUMBING FIXTURES FROM THE EFFECTS OF CLEANING. FLUSH SURFACES WITH CLEAN WATER BEFORE AND AFTER CLEANING.

GENERAL PAINT NOTES


- CONTRACTOR SHALL FIELD VERIFY EXTENT OF PAINTING AND COLORS REQUIRED. SUBMIT DRAM-DOWNS OF EACH COLOR TO ARCHITECT FOR APPROVAL PRIOR TO INSTALLATION.
- SURFACES NOTED TO BE PAINTED, AS WELL AS FLOORS AND ADJACENT SURFACES, SHALL BE CLEAN, MILDEW, EFFLORESCENCE, AND ALL FOREIGN MATERIAL SHALL BE REMOVED FROM SURFACES BY APPROPRIATE METHODS. PREPARE SURFACES PER MANUFACTURER'S RECOMMENDATIONS.
- PRIME ALL UNFINISHED SURFACES SCHEDULED TO RECEIVE WALLCOVERING OR PAINT PRIOR TO FINISHING AS RECOMMENDED BY MANUFACTURER'S WRITTEN RECOMMENDATIONS FOR EACH SUBSTRATE.
- CONTRACTOR SHALL APPLY ALL PAINT IN ACCORDANCE WITH MANUFACTURER'S RECOMMENDATIONS. ALL COATS MUST BE THOROUGHLY DRY BEFORE APPLYING SUCCEEDING COATS. USE APPLICATIONS AND TECHNIQUES BEST SUITED FOR SUBSTRATE AND TYPE OF MATERIAL BEING APPLIED. PROVIDE TOTAL NUMBER OF COATS AS REQUIRED TO COVER.

PAINT SCHEDULE

- ALL PAINTS SHALL BE LATEX-BASED, AS INDICATED IN FINISH SCHEDULE. HOLLOW METAL DOORS AND FRAMES SHALL BE PAINTED WITH ENAMEL-BASED PAINT. NO SUBSTITUTIONS.
- ALL UNFINISHED WALLBOARD INDICATED TO RECEIVE PAINT OR WALLCOVERING SHALL BE PRIMED WITH ONE (1) COAT SHERWIN-WILLIAMS MULTI-PURPOSE LATEX PRIMER/SEALER.
- ALL UNFINISHED PLYWOOD INDICATED TO RECEIVE PAINT SHALL BE PRIMED WITH ONE (1) COAT SHERWIN-WILLIAMS MULTI-PURPOSE LATEX PRIMER/SEALER.
- ALL UNPAINTED CMU SURFACES INDICATED TO RECEIVE PAINT SHALL RECEIVE ONE COAT OF LATEX BASED INTERIOR/EXTERIOR BLOCK FILLER, THEN LATEX FINISH COATS AS NOTED ABOVE FOR TYPE OF SURFACE.
- ALL UNPRIMED METAL SURFACES INDICATED TO RECEIVE PAINT, INCLUDING LINTELS AND HOLLOW METAL DOORS AND FRAMES, SHALL BE PRIMED WITH ONE (1) COAT RUST-INHIBITING PRIMER (BENJAMIN MOORE ALKYD ENAMEL UNDER BODY PRIMER). EXTERIOR LINTEL, DOOR & FRAME COLOR SHALL MATCH EXISTING EXTERIOR ADJACENT MATERIAL COLOR UNLESS NOTED OTHERWISE.
- ALL WALLS AND VERTICAL SURFACES OF SOFFITS AND HEADERS INDICATED TO RECEIVE PAINT SHALL RECEIVE MINIMUM OF TWO (2) COATS OF COLOR INDICATED ON PLAN. PAINT FINISH SHALL BE LOW-LUSTER EGGSHELL (OR SATIN) ACRYLIC LATEX, UNLESS NOTED OTHERWISE. PAINT WALLS (PT-1), UNLESS NOTED OTHERWISE.
- ALL CEILINGS OR SOFFITS INDICATED TO RECEIVE PAINT SHALL RECEIVE MINIMUM OF TWO (2) COATS OF COLOR INDICATED ON PLAN. PAINT FINISH SHALL BE FLAT, UNLESS NOTED OTHERWISE.
- ALL INTERIOR HOLLOW METAL DOORS AND FRAMES INDICATED TO RECEIVE PAINT SHALL BE PAINTED AS NOTED IN FINISH SCHEDULE. SEE FINISH SCHEDULE ON DRAWING A8-1.
- ALL MISCELLANEOUS METAL SURFACES SHOWN TO BE PAINTED SHALL RECEIVE MINIMUM OF TWO (2) COATS, ALKYD ENAMEL PAINT, FINISH SEMI-GLOSS, COLOR AS INDICATED.
- PAINTS AND COATINGS SHALL COMPLY WITH THE FOLLOWING VOC LIMIT (GRAMS/LITER LESS WATER):
 - ARCHITECTURAL PAINTS, PRIMERS AND COATINGS - GREEN SEAL STANDARD 65-11, 1993.
 - FLATS: 50 G/L
 - NON-FLATS: 150 G/L
 - ANTI-RUST PAINTS - GREEN SEAL STANDARD 66-03, 1997
 - APPLIED TO FERROUS METAL: 250 G/L
 - CLEAR WOOD FINISHES, STAINS, SEALERS, SHELLACS - SCAGMD RULE 113, 2004
 - LACQUER: 350 G/L
 - WATERPROOF SEALERS: 250 G/L
 - SANDING SEALERS: 215 G/L
 - OTHER SEALERS: 200 G/L
 - STAINS: 250 G/L
- PROVIDE PAINTS AS NOTED ON THE FINISH SCHEDULE. PAINTS MAY BE COLOR MATCHED. ACCEPTABLE MANUFACTURERS ARE AS FOLLOWS: BENJAMIN MOORE, DUNN EDWARDS, GLIDDEN, SHERWIN-WILLIAMS, ARCHITECT APPROVED EQUAL.

FINISH KEY

- | | |
|--------|--------------------------------------|
| XX-X | DENOTES WALL FINISH U.N.O. |
| XX-X | DENOTES FLOOR FINISH |
| XX-X | DENOTES WALL BASE |
| XX-X | DENOTES FINISH ON SPECIFIC SURFACE |
| (XX-X) | DENOTES FINISH ON REFERENCED SURFACE |

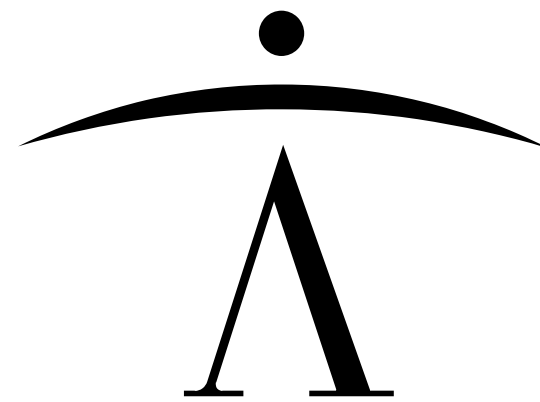

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Signature _____ Date 2022-10-20

Drawing Title:

ENLARGED PLANS &
DETAILS

Issue/ Revision:

| No. | Date | Description |
|-----|------------|-------------------|
| - | 2022-10-20 | For Client Review |

Project Manager: CRN
Project No.: 2022027 Date: 2022-10-20

A3-1

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FLOORING TRANSITIONS

TRANSITIONS BETWEEN FLOORING MATERIALS SHALL OCCUR UNDER CENTERLINE OF DOOR AT ALL DOORWAYS, UNLESS NOTED OR SHOWN OTHERWISE.

CARPET TO VCT OR RESILIENT FLOORING: PROVIDE JOHNSONITE SSR-XX-B REDUCER IN BLACK.

CERAMIC TILE TO CARPET TILE: PROVIDE METAL SCHLUTER DECO TRANSITION IN ANODIZED ALUMINUM AT CARPET EDGE TO CERAMIC TILE - LATEX FLOOR UNDER CARPET FOR SMOOTH TRANSITIONS.

CERAMIC TILE TO BROADLOOM CARPET: PROVIDE METAL SCHLUTER RENO-V TRANSITION IN ANODIZED ALUMINUM AT CARPET EDGE TO CERAMIC TILE.

CERAMIC TILE TO VCT OR RESILIENT FLOORING: PROVIDE METAL SCHLUTER RENO-U TRANSITION IN ANODIZED ALUMINUM. LATEX FLOOR FOR SMOOTH TRANSITION AS REQUIRED.

RESILIENT FLOORING NOTES

- CONTRACTOR SHALL INSTALL RESILIENT FLOORING PER MANUFACTURER'S RECOMMENDATIONS USING MANUFACTURER'S RECOMMENDED ADHESIVES, LEVELING COMPOUNDS, ETC. FOR TYPE OF APPLICATION AND SUBSTRATE. DO NOT USE ADHESIVES HAVING A VOC CONTENT ABOVE 50 G/L (WHEN CALCULATED ACCORDING TO 40 CFR 59, SUBPART D).
- CLEAN AND SEAL RESILIENT FLOORING PER MANUFACTURER'S WRITTEN RECOMMENDATIONS FOR COMMERCIAL HIGH TRAFFIC AREAS.
- POLISH RESILIENT FLOORING ONLY WHEN RECOMMENDED BY MANUFACTURER FOR COMMERCIAL HIGH TRAFFIC AREAS.

CARPET NOTES

- PROVIDE MANUFACTURER'S RECOMMENDED ADHESIVES FOR CARPET INSTALLATION PRODUCED EXPRESSLY FOR USE WITH SELECTED CARPET ON ACTUAL SUBSTRATE. PROVIDE MATERIALS WHICH ARE MILDEW RESISTANT AND COMPLY WITH FLAMMABILITY REQUIREMENTS FOR INSTALLED CARPET. DO NOT USE ADHESIVES HAVING A VOC CONTENT GREATER THAN 50 G/L (WHEN CALCULATED ACCORDING TO 40 CFR 59, SUBPART D).
- PROVIDE MANUFACTURER'S SPECIAL WARRANTY ON CARPET IN WHICH MANUFACTURER AGREES TO REPAIR OR REPLACE COMPONENTS OF CARPET INSTALLATION THAT FAIL IN MATERIALS OR WORKMANSHIP WITHIN 10 YEARS FROM SUBSTANTIAL COMPLETION. WARRANTY DOES NOT INCLUDE DETERIORATION OR FAILURE OF CARPET DUE TO UNUSUAL TRAFFIC, FAILURE OF SUBSTRATE, VANDALISM OR ABUSE. FAILURES INCLUDE, BUT ARE NOT LIMITED TO, MORE THAN 10% LOSS OF FACE FIBER, EDGE RAVELING, SNAGS, RUNS, DELAMINATION AND OTHER RELATED FAILURES.
- CUT AND FIT CARPET TO BUTT TIGHTLY TO VERTICAL SURFACES AND PERMANENT ITEMS. BIND OR SEAL CUT EDGES AS RECOMMENDED BY CARPET MANUFACTURER.
- CLEAN CARPET PER MANUFACTURER'S WRITTEN RECOMMENDATIONS, READY FOR USE BY TENANT.

GENERAL FLOORING NOTES

- CONTRACTOR SHALL PROVIDE ALL MATERIALS REQUIRED FOR FLOORING WORK INDICATED ON THE DRAWINGS. PREPARE FLOOR SUBSTRATE TO RECEIVE NEW FLOORING COMPONENTS AND INSTALL FLOORING COMPONENTS IN COMPLIANCE WITH MANUFACTURER'S WRITTEN RECOMMENDATIONS. FLOOR SUBSTRATE SHALL BE FREE FROM DEFECTS OR DEFORMITIES THAT NEGATIVELY IMPACT THE FLOOR INSTALLATION AND FINISHED APPEARANCE.
- CONTRACTOR SHALL COMPLETE MOISTURE TESTS ON SUBSTRATES PER FLOORING SYSTEM MANUFACTURER'S RECOMMENDATIONS PRIOR TO BEGINNING FLOOR PREPARATIONS.
AT EXISTING SLABS-ON-GRADE:
- TEST SLAB USING IN-SITU PROBES PER ASTM F 2170-11.
- REVIEW SLAB SURFACE AND NOTIFY THE ARCHITECT IF AN EXISTING SURFACE BARRIER SYSTEM EXISTS.
TEST RESULTS SHALL COMPLY WITH MANUFACTURER'S WRITTEN REQUIREMENTS PRIOR TO INSTALLING NEW FLOORING PRODUCTS. SUBMIT FINAL RECORD TEST RESULTS TO ARCHITECT.
- CONTRACTOR SHALL INSTALL ALL FLOORING MATERIALS IN COMPLIANCE WITH MANUFACTURER'S RECOMMENDATIONS USING MANUFACTURER'S RECOMMENDED ADHESIVES, GROUT, ETC. FOR EACH TYPE OF APPLICATION.
- CONTRACTOR SHALL MEASURE WORK AREAS AND ESTABLISH THE LAYOUT OF UNITS TO AVOID USE OF LESS-THAN-HALF-WIDTH UNITS AT BORDER, WHERE FLOORING PLAN CONFLICTS WITH THE ABOVE REQUIREMENTS, NOTIFY ARCHITECT FOR CLARIFICATION PRIOR TO INSTALLATION.
- CONTRACTOR SHALL ADJUST FLOORING TIGHTLY TO VERTICAL SURFACES, SCRIBE AS NECESSARY AROUND OBSTRUCTIONS TO PRODUCE NEAT JOINTS LAID TIGHT, EVEN, AND IN STRAIGHT PARALLEL LINES.
- CONTRACTOR SHALL EXTEND FLOORING UNDER MOVABLE EQUIPMENT, OPEN-BOTTOM AND RAISED-BOTTOM OBSTRUCTIONS, REMOVABLE FLANGES OF OBSTRUCTIONS, AND INTO ALCOVES UNLESS OTHER FLOOR FINISHES ARE INDICATED.
- CONTRACTOR SHALL PROVIDE COVER PLATES ON PLUMBING AND ELECTRICAL DEVICES WHICH MAINTAIN OVERALL CONTINUITY OF COLOR, JOINTS, AND PATTERN OF FLOORING MATERIALS AND PROVIDE ACCESS TO DEVICE.
- THE FLOORING SYSTEM INSTALLER SHALL PROVIDE SYSTEM INSTALLATIONS COMPLETE IN EVERY RESPECT, INCLUDING TRANSITION STRIPS (MATERIAL AND COLOR AS NOTED), READY FOR OCCUPANCY BY OWNER. FOR TRANSITIONS BETWEEN DISSIMILAR FLOORING MATERIALS, REFER TO FLOORING TRANSITION NOTES ON THIS SHEET.

GENERAL FINISH PLAN NOTES

GENERAL FINISH NOTES

- CONTRACTOR SHALL VERIFY WITH PRODUCT MANUFACTURERS THAT ALL FINISH MATERIALS COMPLY WITH CODE REQUIRED INTERIOR FINISH CRITERIA NOTED BELOW.
- ALL MATERIALS AND FINISHES SHALL BE INSTALLED IN ACCORDANCE WITH MANUFACTURER'S WRITTEN INSTRUCTIONS, AND MEET ALL INDUSTRY STANDARDS AND REQUIREMENTS.
- ALL NEW ELECTRICAL OUTLETS, DEVICES AND COVER PLATES SHALL BE COMMERCIAL GRADE DEVICES THAT MATCH EXISTING BUILDING STANDARD.
- NEW CONDUIT SHALL NOT BE RUN EXPOSED WITHOUT THE PRIOR ACCEPTANCE OF THE ARCHITECT. WHEN ALLOWED BY THE ARCHITECT, EXPOSED CONDUIT/SURFACE MOUNTED RACEWAYS SHALL BE RUN SQUARE AND PLUMB WITH BUILDING COMPONENTS. PAINT TO MATCH THE ADJACENT SURFACE UNLESS NOTED OTHERWISE.
- ALL NEW DUCTWORK EXPOSED TO VIEW IN PUBLIC SPACES SHALL BE PAINTED TO MATCH THE ADJACENT SURFACE UNLESS NOTED OTHERWISE.
- REFER TO INTERIOR ELEVATIONS FOR WALL FINISHES NOT NOTED ON PLAN.
- SEE DRAWING A3-1 FOR ADDITIONAL GENERAL FINISH NOTES.

CODE REQUIRED INTERIOR FINISH CRITERIA:

SPRINKLERED SOUTH WING OF SCHOOL:

- CONTRACTOR SHALL PROVIDE INTERIOR FINISH MATERIALS THAT MEET THE FOLLOWING CRITERIA: (PER IBC 2018, TABLE 803.13 - SPRINKLERED AND SECTION 804.4.2)
A. INTERIOR WALLS AND CEILING FINISHES SHALL BE AS FOLLOWS PER ASTM E84:
- EXIT CORRIDORS: CLASS C (FS 16-200, SD 0-450)
- ROOMS AND ENCLOSED SPACES: CLASS C (FS 16-200, SD 0-450)
B. FOR FLOOR FINISHES: CLASS II (CRITICAL RADIANT FLUX 0.22 WATTS/SQ. CM) PER NFPA 253 AND COMPLY WITH DOC FF-1 PILL TEST (CPSC 16 CFR, PART 1630).


NON-SPRINKLERED PORTION OF BUILDING:

- CONTRACTOR SHALL PROVIDE INTERIOR FINISH MATERIALS THAT MEET THE FOLLOWING CRITERIA: (PER IBC 2018, TABLE 803.13 - NOT SPRINKLERED)
A. INTERIOR WALLS AND CEILING FINISHES SHALL BE AS FOLLOWS PER ASTM E84:
- EXIT CORRIDORS: CLASS B (FS 26-75, SD 0-450)
- ROOMS AND ENCLOSED SPACES: CLASS C (FS 16-200, SD 0-450)
B. FOR FLOOR FINISHES: CLASS II (CRITICAL RADIANT FLUX 0.22 WATTS/SQ. CM) PER NFPA 253 AND COMPLY WITH DOC FF-1 PILL TEST (CPSC 16 CFR, PART 1630).

| FINISH KEY | |
|------------|--------------------------------------|
| XX-X | DENOTES WALL FINISH U.N.O. |
| XX-X | DENOTES FLOOR FINISH |
| XX-X | DENOTES WALL BASE |
| XX-X | DENOTES FINISH ON SPECIFIC SURFACE |
| [XX-X] | DENOTES FINISH ON REFERENCED SURFACE |

FIRE RATING LEGEND

| | |
|----------------|------|
| 2 hour | ---- |
| 1 hour | ---- |
| 45 minute | ---- |
| 30 minute | ---- |
| ONE HOUR SMOKE | ---- |
| MATCH LINE | ---- |

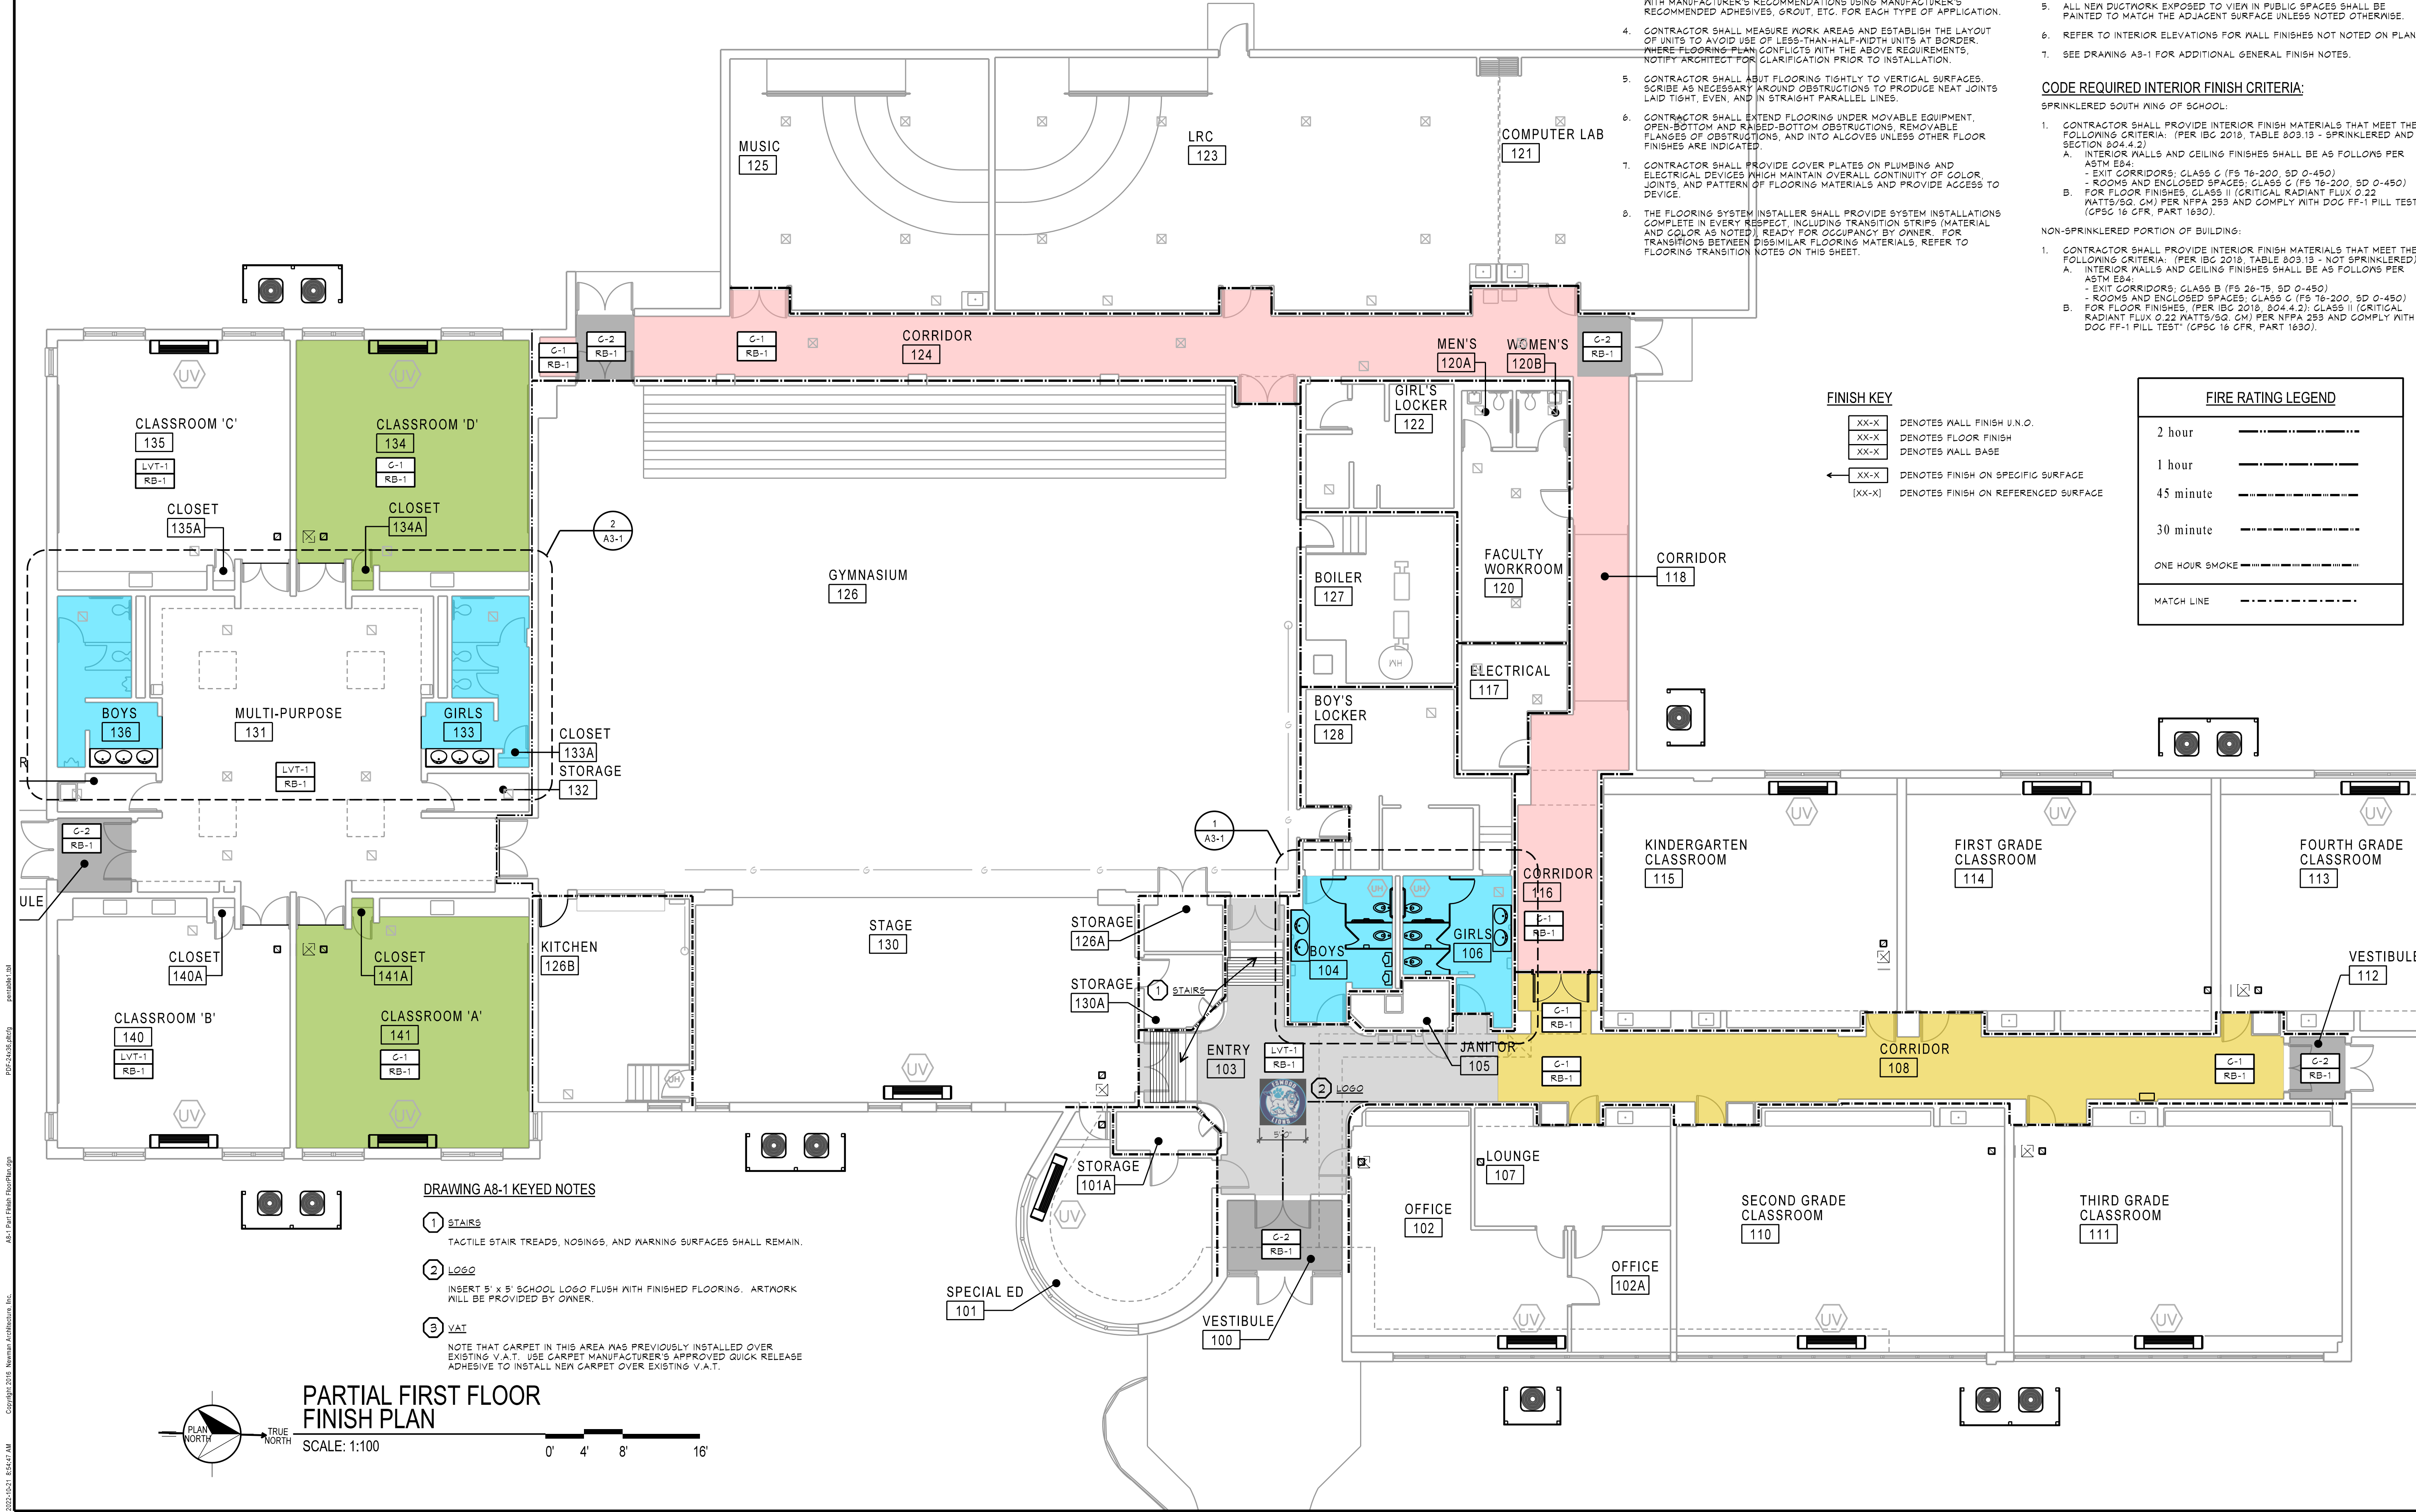


DRAWING A8-1 KEYED NOTES

- STAIRS**
TACTILE STAIR TREADS, NOSINGS, AND WARNING SURFACES SHALL REMAIN.
- LOGO**
INSERT 5' x 5' SCHOOL LOGO FLUSH WITH FINISHED FLOORING. ARTWORK WILL BE PROVIDED BY OWNER.
- VAT**
NOTE THAT CARPET IN THIS AREA WAS PREVIOUSLY INSTALLED OVER EXISTING V.A.T. USE CARPET MANUFACTURER'S APPROVED QUICK RELEASE ADHESIVE TO INSTALL NEW CARPET OVER EXISTING V.A.T.

PARTIAL FIRST FLOOR FINISH PLAN

SCALE: 1:100

0' 4' 8' 16'

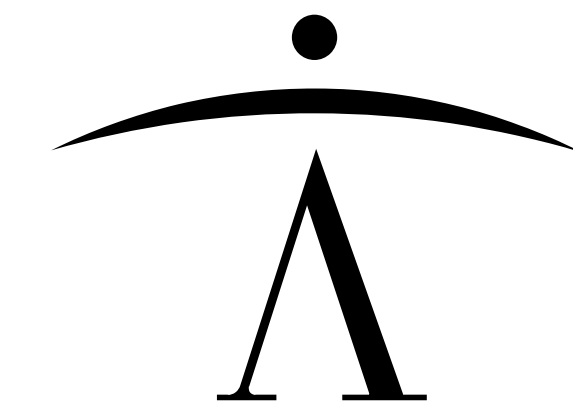

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(630) 420-1600 FAX (630) 420-1987 www.newmanarchitecture.com

Project Name:

CONSTRUCTION DOCUMENTS

ESWOOD SCHOOL

BUILDING IMPROVEMENTS - SUMMER 2023

ESWOOD ELEMENTARY SCHOOL
304 N. MAIN STREET
LINDENWOOD, ILLINOIS 61049

FOR
BOARD OF EDUCATION
ESWOOD CCSD 269

Architect's Certification:

License: Illinois Professional Design Firm
License No. 184-000549
Expires: 2023-04-30
License: Illinois Registration No. 001-009496
Expires: 2022-11-30


Signature _____ Date 2022-10-20

Drawing Title:
PARTIAL FIRST FLOOR FINISH PLAN

Issue/ Revision:
No. Date Description
- 2022-10-20 For Client Review

Project Manager: CRN
Project No.: 2022027 Date: 2022-10-20

A8-1

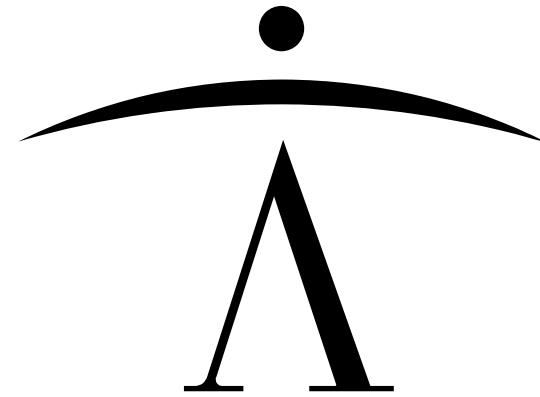

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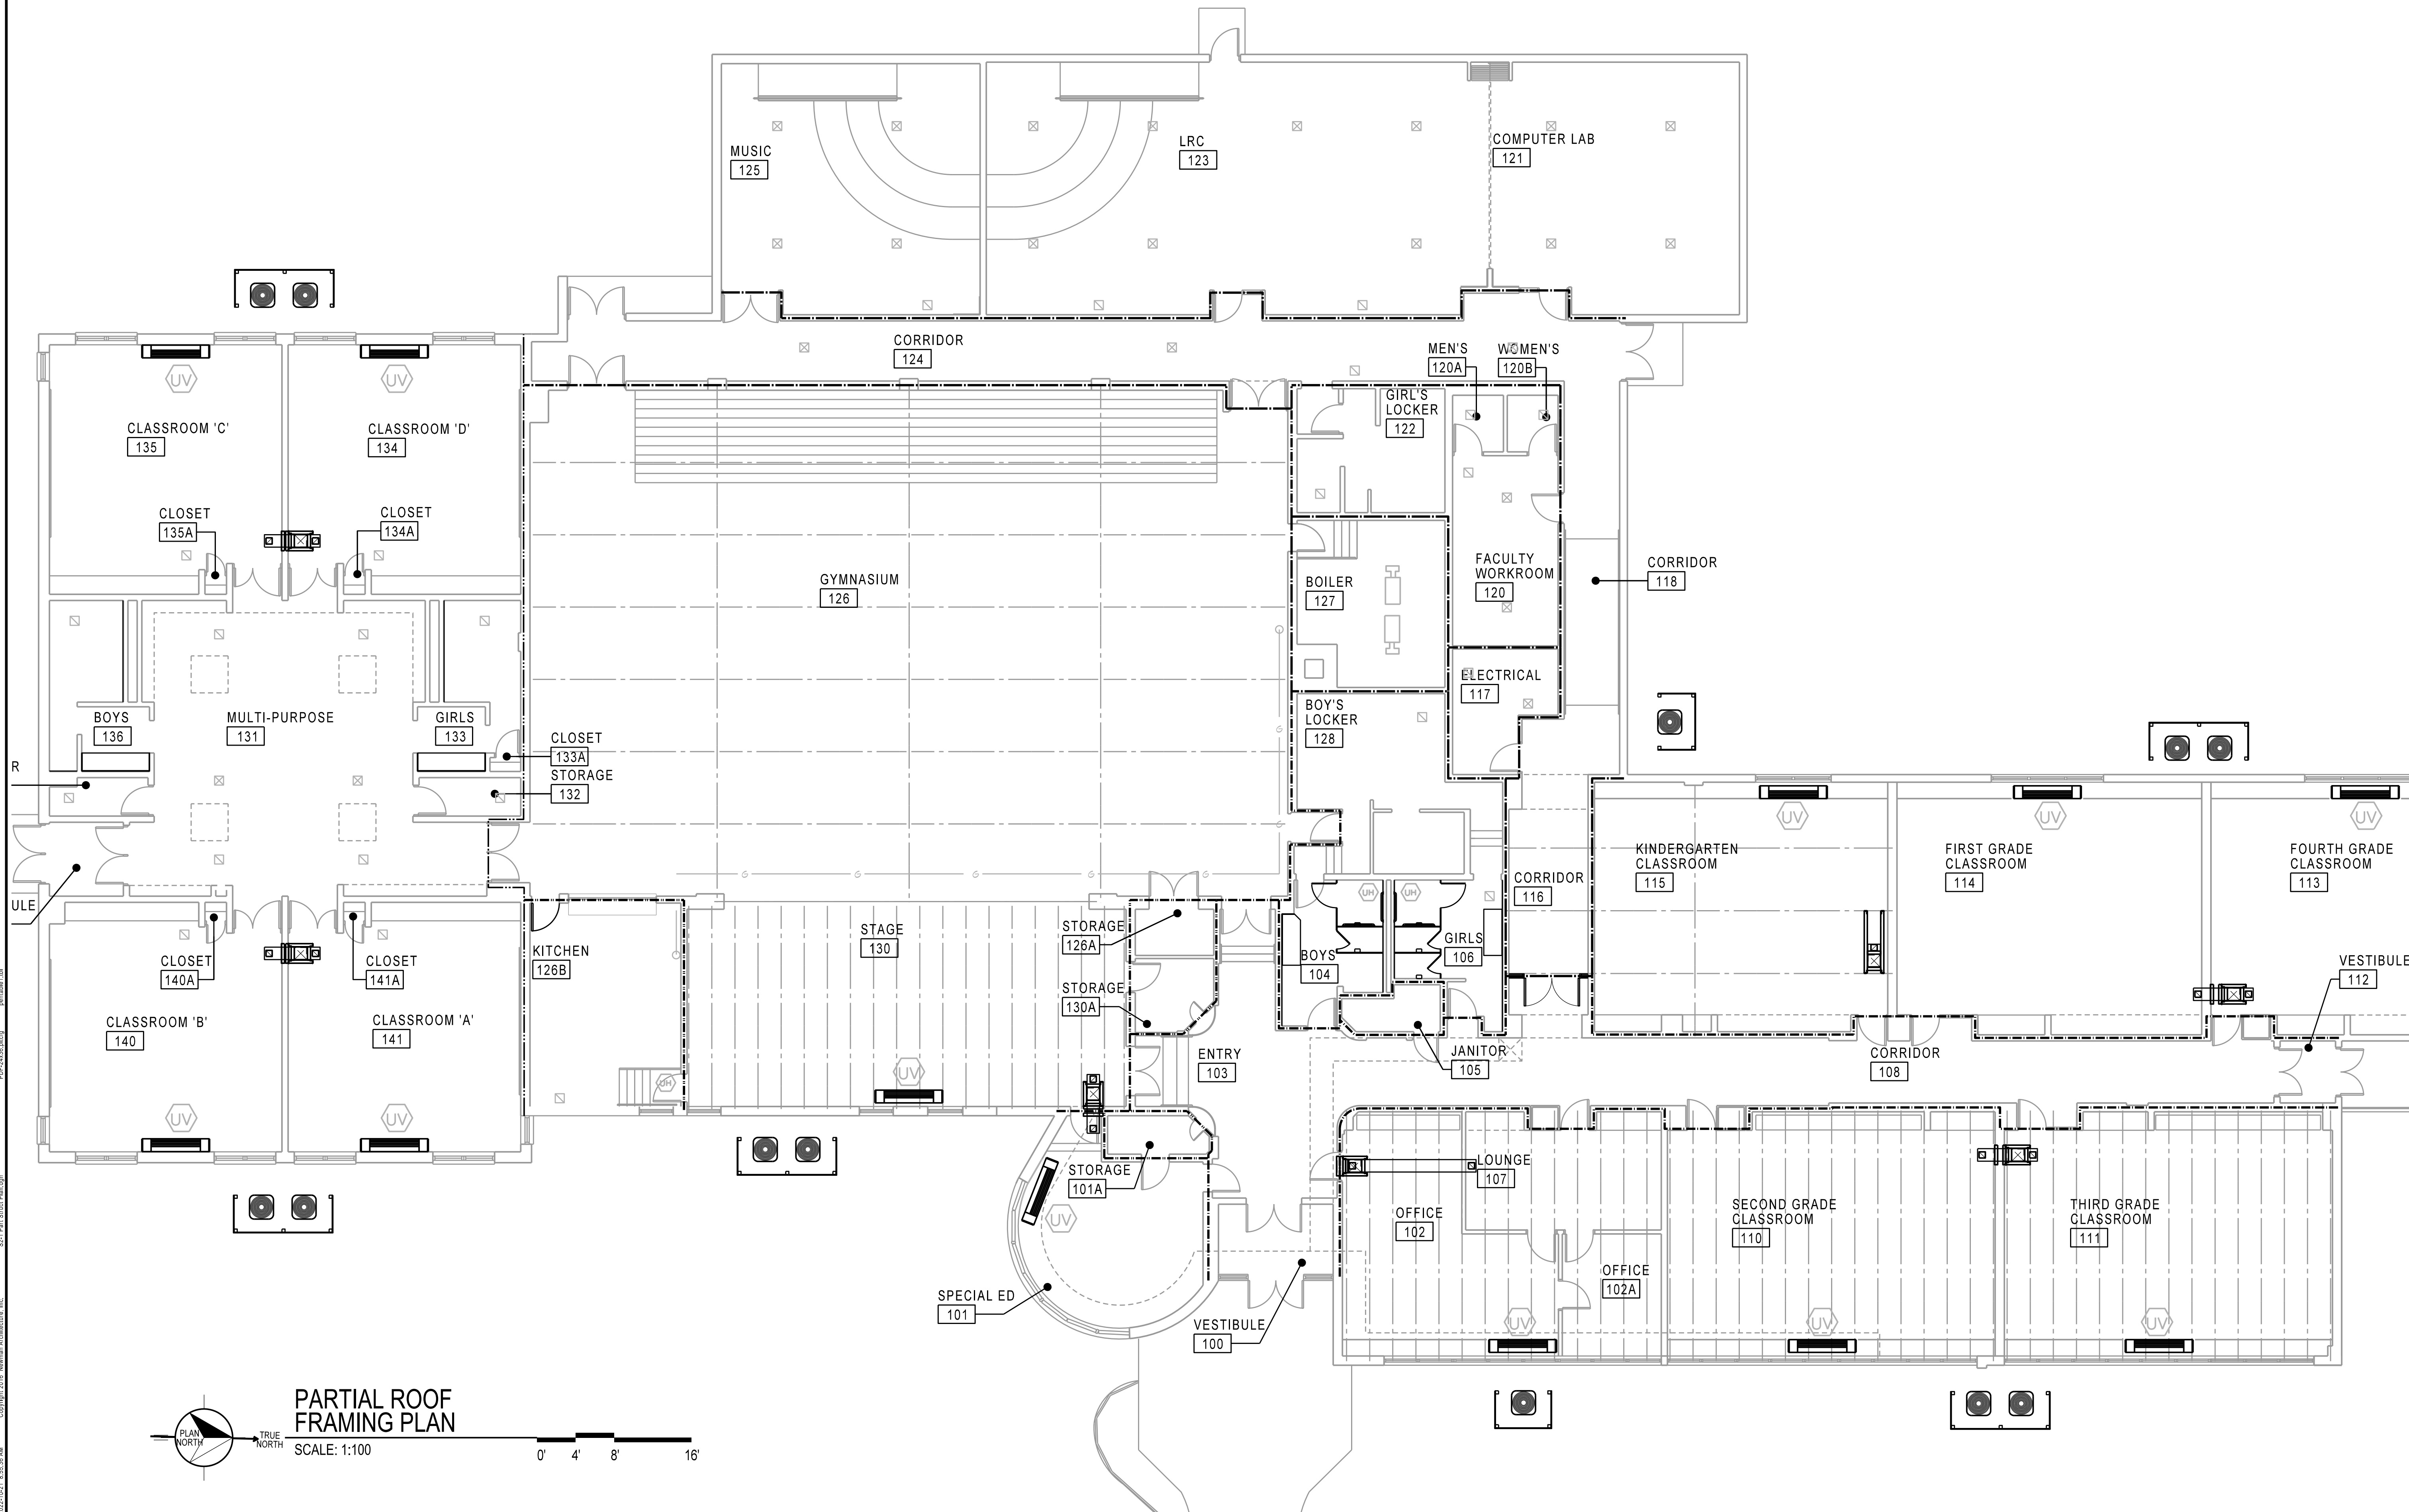
Drawing Title:
PARTIAL ROOF FRAMING PLAN

Issue/ Revision:


| No. | Date | Description |
|-----|------------|-------------------|
| - | 2022-10-20 | For Client Review |

Project Manager: CRN
Project No.: 2022027 Date: 2022-10-20


S2-1



2023-10-21 9:02:10 AM
Copyright 2015 Newman Architecture, Inc.
M2-1 First Floor Mechanical Plan
RPF/CAJ/2023/10/21

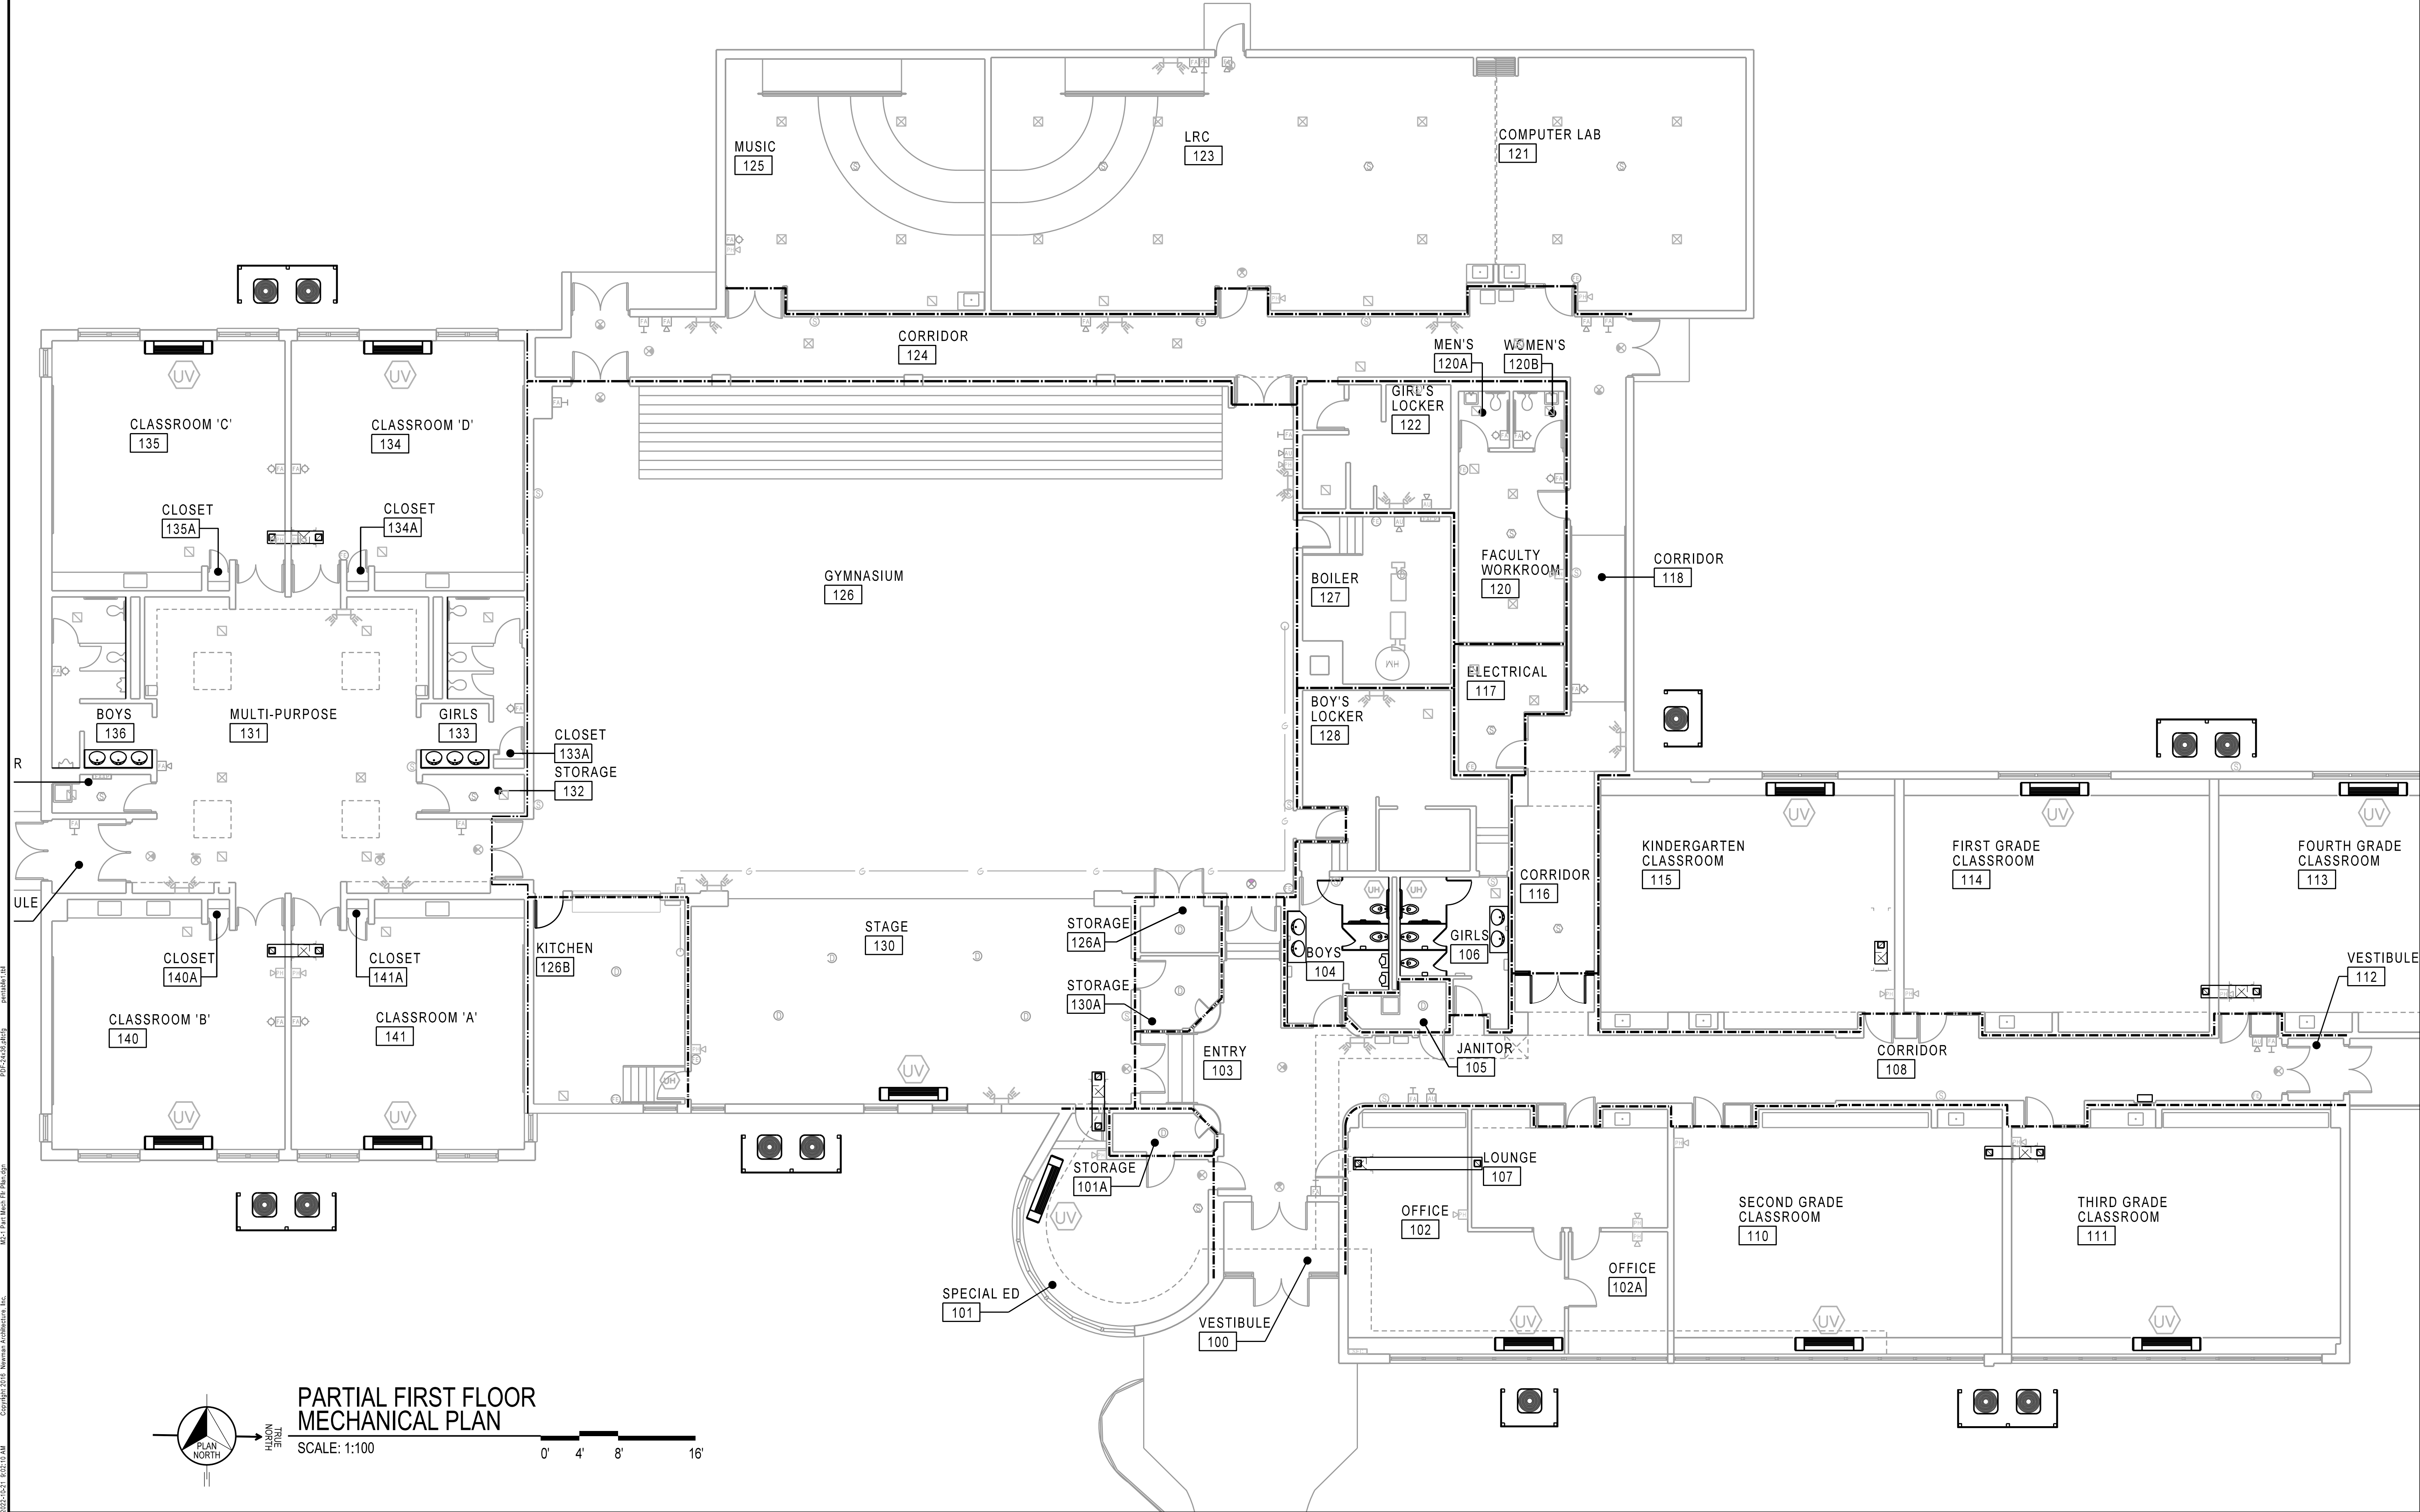

| FIRE RATING LEGEND | |
|--------------------|-----------|
| 2 hour | ===== |
| 1 hour | ----- |
| 45 minute | - - - - - |
| 30 minute | - . - . - |
| 20 minute / 1/3 HR | - . - - - |
| ONE HOUR SMOKE | ===== |

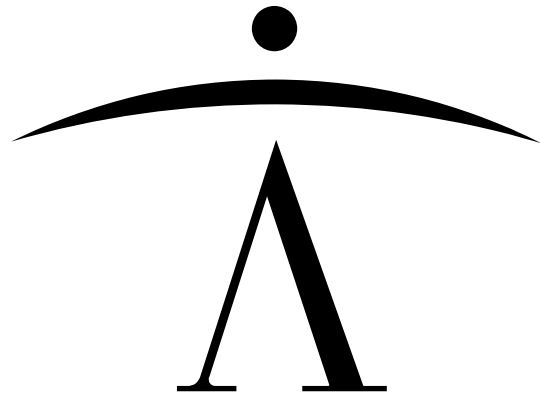

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Expires: 2022-11-30

Signature _____ Date 2022-10-20

Drawing Title:
**PARTIAL FIRST FLOOR
MECHANICAL PLAN**

Issue/ Revision:

| No. | Date | Description |
|-----|------------|-------------------|
| - | 2022-10-20 | For Client Review |

Project Manager: CRN
Project No.: 2022027 Date: 2022-10-20

M2-1